CITY OF SAINT PAUL HERITAGE PRESERVATION COMMISSION STAFF REPORT

FILE NAME: 882 West Seventh Street INVENTORY NUMBER: RA-SPC-2937

APPLICANT: Craig Cohen

ARCHITECT: Jerry Hagen, Hagen Christensen & McIlwain Architects

DATE OF PUBLIC HEARING: February 8, 2018

HPC SITE/DISTRICT: Jacob Schmidt Brewing Company Historic District

PERIOD OF SIGNIFICANCE: 1858-1955

CATEGORY: Contributing WARD: 2 DISTRICT COUNCIL: 9

ZONING: T3 **CLASSIFICATION:** Restoration

STAFF INVESTIGATION AND REPORT: George Gause

A. SITE DESCRIPTION:

The Office Building was constructed in 1935 in a Streamline Moderne style. The U-shaped building is a masonry structure faced in orange-tan brick and trimmed in Bedford stone. The main entry is at the center of the Seventh Street elevation, with an elaborate architrave made up of broad, fluted pilasters, a wide lintel, and a carved rendition of the circular Jacob Schmidt Brewing Company logo. A portion of the interior is locally designated including the lower level Rathskeller.

B. PROPOSED CHANGES:

The applicant proposes to rehabilitate the building in the following areas:

Exterior Surfaces:

- *Masonry:* Cleaning will be conducted only to halt deterioration. Missing, damaged, and deteriorated details will be repaired to match the existing.
- *Masonry:* Deteriorated brick, stone, mortar, and other materials will be restored where damaged, the original style, color and proportion being replicated.
- Masonry: The front entry stone trim, detail and original lighting fixtures will be restored and preserved.
- Windows: Provide repairs to existing original wood windows throughout. Replace existing
 newer anodized aluminum windows at west and south elevations with new clad wood
 windows to match original profile.
- Doors: The original front door (Seventh Street facade) will be reinstalled and hardware will be upgraded to meet the historic and building code requirements. Non-original doors on the south, west, southwest and north wing will be replaced with compatible new doors. Southeast facade stoop will also be replaced and reconstructed.

Interior Spaces:

- Structural Repairs: The west portion of the building has a wood framed floor and roof
 system. There are significant expansion cracks in the floor and walls at various locations
 which telegraph the change in construction type and a lack of expansion control between
 them. This will be addressed. Much of the original wood roof and floor framing in the
 western side of the building is undersized and failing to some degree. This is the area built
 over part of the old building reusing existing foundations. Repair this portion of the
 structure as a part of the building stabilization.
- *Masonry:* Provide interior masonry restoration work at historical spaces including the Rathskeller, Tasting Room, Front Stair, Lobby, and at exposed wall in new Lower Level.
- Doors: Where existing spaces are retained the original historic paneled doors (and hardware) will be repaired rather than replaced. If replacement of original or historic doors is necessary, the replacement will duplicate or be compatible with the material, design, and hardware of the older door.

- Provide new doors to match existing door system at new openings. Provide glass doors and sidelights at interior entrances where indicated in the plans.
- *Mechanical*: Install an automatic fire protection system for the entire building.
- Heating & Air Conditioning: The building will need significant HVAC work. Reuse ductwork where possible, but the majority of the piping, ductwork and equipment will be new.
- . *Electrical*: The existing electrical system is to be modified to address the use needs for the building owner and tenants. Existing historic light fixtures will remain.

Lower Level Site Plan:

- The Rathskeller, Tasting Room and Bar will be renovated as original. The rest of the lower level will include an additional event or tenant space (where the existing gift shop is located), restrooms, lobby, utility areas, etc. as required.
- *Masonry Flooring:* Strip old finish off existing stone flooring in the Rathskeller space and at base of stairs and provide new clear finish.

First Floor Site Plan:

- The existing art deco hand railing from the first floor to the Rathskeller is to be retained and repaired as necessary.
- Provide repair work for ornamental stair railing in the front lobby and stairs to Rathskeller.
- Flooring: Composite tile flooring is worn and has deteriorated. Replace with new composite tile flooring to replicating the existing pattern. In the north wing, replace the flooring with new composite tile flooring replicating the existing pattern. This includes the two locations with the Schmidt logo.

C. BACKGROUND:

The restoration plans for the Jacob Schmidt office building and Rathskeller were conditionally approved by the HPC in 2012. Since that time there has been an ownership change and some changes to the proposed plans:

- 1. West façade: The existing door will be restored into a compatible door. 2012 plan proposed conversion into a window.
- 2. South façade: Metal replacement windows will be replaced with wood clad windows to match the original. 2012 plan retained the metal windows.
- 3. Southeast façade: Existing entry will be restored with a compatible door. 2012 plan new entry structure was proposed.
- 4. East façade: 2012 plan proposed a new garbage and mechanical structure. This structure will not be constructed.

D. **GUIDELINE CITATIONS:**

E. The Secretary of the Interior's Standards for Rehabilitation

Guideline	Meets Guideline?	Comments
1. A property shall be used for its historic purpose or be placed in a new use that requires minimal change to the defining characteristics of the building and its site and environment.	Yes	The renovation will respect the layout and history of the structure while adapting for a new use.
2. The historic character of a property will be retained and preserved. The removal of distinctive materials or alteration of features, spaces, and spatial relationships that characterize a property will be avoided.	Yes	The renovation will respect the layout and history of the structure while adapting for a new use.

5. Distinctive materials, features, finishes, and construction techniques or examples of craftsmanship that characterize a property will be preserved.	Yes	Original materials will be retained. Where missing, materials will match the original.
6. Deteriorated historic features will be repaired rather than replaced. Where the severity of deterioration requires replacement of a distinctive feature, the new feature will match the old in design, color, texture, and, where possible, materials. Replacement of missing features will be substantiated by documentary and physical evidence.	Yes	Much of the program is to repair deteriorated features and materials.
7. Chemical or physical treatments, such as sandblasting, that cause damage to historic materials shall not be used. The surface cleaning of structures, if appropriate, shall be undertaken using the gentlest means possible.	Yes	Surface cleaning will be done using the gentlest means possible.

F. Sec. 74-08 Jacob Schmidt Brewing Company Preservation Program

(4) Existing Structures and buildings

Guideline	Meets Guideline?	Comments
a. Exterior Surfaces. Masonry. Repair: Original masonry and mortar shall be retained whenever possible without the application of any surface treatment. Deteriorated or damaged masonry or mortar, when necessary, shall be repaired or replaced with the material used in original construction or a material that closely resembles the original in size, shape, color, texture and profile.	Yes	Restoration plans call for the retention of original fabric and replacement material that matches the original.
a. Exterior Surfaces. Masonry. Cleaning: Masonry should be cleaned only when necessary to halt deterioration or to remove graffiti and stains and always with the gentlest method possible such as low pressure water (under 300 psi) and soft, natural bristle brushes.	Yes	Surface cleaning will be done using the gentlest means possible. Staff is conditioning any cleaning of the structure.
a. Exterior Surfaces. Masonry. Repointing: Repointing should be done on those mortar joints where there is evidence of moisture problems or where mortar is missing or damaged. The removal of mortar shall be done with methods and tools that will not damage the surrounding masonry or alter the joint size. Original mortar joint size and profile shall be retained, and replacement mortar shall match the original mortar in color, composition, strength and texture.	Yes	Repointing plans call for the retention of original fabric and replacement material that matches the original.

e. Windows and Doors. Panes, Sashes and Hardware: Historic windows should be preserved and if replacement is warranted, windows should be replaced in-kind. Missing or irreparable windows should be replaced with new windows that match the original in material, size, general muntin and mullion proportion and configuration and reflective qualities of the glass.	Yes	Existing original windows will be repaired. Non-original existing windows will be replaced with windows to match the original windows.
e. Windows and Doors. Trim: Historic window casings should be retained wherever possible. If replacement is necessary, the original profile shall be replicated.	Yes	Existing original window trim will be repaired. Non-original existing windows will be replaced with windows and trim to match the original windows.
h. Mechanical. Location and Siting. Mechanical related equipment should be sited in such a way that they do not block or disrupt principal elevations and prominent views, especially on roof tops.	Yes	Mechanical systems will be placed on the rooftop to minimize the effect on the structure.
6. Interiors b. Interior Spaces. Identifying, retaining, and preserving a floor plan or interior spaces that are important in defining the overall historic character of the building.	Yes	In the designated area of the structure, the original floorplan will be retained.
6. Interiors c. Interior Features and Finishes. Identifying, retaining and preserving interior features and finishes that are important in defining the overall historic character of the building.	Yes	Nothing pertaining to the designated interior portions will be altered. The spaces will be preserved, repaired where needed and rehabilitated.
6. Interiors e. New Mechanical Systems. Installing a completely new mechanical system if required for the new use so that it causes the least alteration possible to the building's floor plan, the exterior elevation, and the least damage to the historic building material.	Yes	Nothing pertaining to the designated interior portions will be altered.

G. FINDINGS:

- 1. On May 25, 2011, the Jacob Schmidt Brewing Company Heritage District was established under Ordinance No. 11-46, § 1. The Heritage Preservation Commission shall protect the architectural character of heritage preservation sites through review and approval or denial of applications for city permits for exterior work within designated heritage preservation sites §73.04.(4).
- 2. The building is categorized as contributing to the character of the Jacob Schmidt Brewing Company Heritage District.
- 3. The Period of Significance for the Jacob Schmidt Brewing Company Heritage Preservation District is 1858-1955.
- 4. *Masonry.* The proposal to clean and repoint where necessary meets the Secretary of the Interior's Standards for Rehabilitation and Meets § 74-08 Preservation Program: Jacob Schmidt Brewing Company Heritage District.

- 5. Windows and doors. Repairing the original wood windows and replacing the non-historic windows and doors with more appropriately detailed windows meets the Secretary of the Interior's Standards for Rehabilitation and Meets § 74-08 Preservation Program: Jacob Schmidt Brewing Company Heritage District.
- 6. Internal spaces: In general, much of the character-defining features are being repaired and preserved which meets the Secretary of the Interior's Standards for Rehabilitation and Meets § 74-08 Preservation Program: Jacob Schmidt Brewing Company Heritage District.
- 7. The proposal for interior and exterior restoration of the structure at 882 West 7th Street will not adversely affect the Program for the Preservation and architectural control of the Jacob Schmidt Brewing Company Heritage Preservation District (Leg. Code §73.06 (e)) so long as the conditions are met.

E. STAFF RECOMMENDATION:

Based on the findings, staff recommends approval with the following conditions:

- 1. All final materials, mock-ups, colors and details shall be submitted to the HPC staff for final review and approval.
- 2. Any revisions to approved plans shall be re-reviewed and approved by the HPC staff. If revisions are significant, new plans may need to be drafted and submitted for final review and approval.
- 3. There shall be no application of sealant, consolidant, or water-proofing product to the stone, granite, or brick.
- 4. The HPC stamped approved plans shall remain available on site for the duration of the project.
- 5. Items not listed in project scope have not been reviewed. Any changes or additions require further review.
- 6. This Certificate is VOID if the approved plans are altered from the Heritage Preservation approved plans.
- 7. All measurements and relationships of existing conditions and new construction shall be field checked for accuracy with submitted plans at the responsibility of the applicant. Inaccuracies or differences should be reported to HPC staff prior to commencement.
- 8. As the proposed project will be conducted over various climate seasons, a weather protection plan should be in place that ensures protection to the historic structure, without damage, for all native temperatures and conditions.
 9. Two separate mortar tests of not less than eight inches in length and on an

0.	aconspicuous facade shall be completed prior to commencement of re-pointing. All neasurements, textures, color, patterns and relationships of existing mortar conditions
	hall be field checked:
	taff Date
10	IPC staff shall be contacted for a site visit to review a sample patch of no more than 'x 5' of the chosen cleaning method to review the work and results. Work shall not rogress beyond this stage without staff sign-off.
	taff Date

F. SUGGESTED MOTION

I move to conditionally approve application #18-012 for interior and exterior restoration at 882 West 7th Street as per the findings of fact, presented testimony, submitted documentation and information provided in the staff report with the 8 conditions.

G. ATTACHMENTS:

- 1. HPC design review application
- 2. Supporting information submitted by applicant plans & photos



Saint Department Depar

Saint Paul Heritage Preservation Commission
Department of Planning and Economic Development
25 Fourth Street West, Suite 1400
Saint Paul, MN 55102
Phone: (651) 266-9078
ApplyHPC@stpaul.gov

Heritage Preservation Commission Design Review Application

PROCESS

This application must be completed in addition to required city permit applications for individually designated Heritage Preservation Sites and properties located within Heritage Preservation Districts.

Design review applications are reviewed and approved by either heritage preservation staff or the Heritage Preservation Commission (HPC) at a public hearing. HPC staff are authorized to approve work that complies with adopted design review guidelines and preservation programs, available at our website www.stpaul.gov/hpc, while the HPC reviews projects that are significant alterations, demolitions, additions, new construction or proposals that do not comply with HPC guidelines. The decision of whether a proposal may be reviewed and approved by HPC staff or must be reviewed by the HPC at a public hearing is made once a complete application is submitted.

The HPC public hearing schedule is viewable here:

https://www.stpaul.gov/departments/planning-economic-development/heritage-preservation/heritage-preservation-commission

A complete application consists of:

- 1) An application form
- 2) Required attachments that adequately describe the proposed work (see attached checklist)

An incomplete application will be put on hold and staff will contact you for additional information. If an application is incomplete for 30 days after it was received, it will be returned to the applicant.

Complete applications will be reviewed in the order they are received. **Applications are not entered in queue to be reviewed until staff has determined them to be complete.** Once reviewed, a Certificate of Approval will be issued along with any conditions for the proposed work. You will be notified by staff when the Certificate of Approval has been issued and a copy will be sent to the Department of Safety and Inspections (DSI) to complete the HPC process of obtaining the necessary permit(s).

1. CATEGORY		
Please check the category tha	at best describes the propose	ed work
■ Repair/Rehabilitation ☐ Moving ☐ Demolition	☐ Sign/Awning ☐ Fence/Retaining Wall ☐ Other	☐ New Construction/Addition/ Alteration ☐ Pre-Application Review Only
2. PROJECT ADDRESS		
Street and number: 882 W	est Seventh Street	Zip Code: <u>55102</u>

3. APPLICANT INFORMATION
Name of contact person: Meghan Elliott
Company: PVN
Street and number: 575 9th Street SE, Suite 215
City: Minneapolis State: MN Zip Code: 55414 Phone number: (612) 843-4140 e-mail: elliott@pvnworks.com
4. PROPERTY OWNER(S) INFORMATION (If different from applicant)
Name: Rathskeller Renaissance, LLC (Craig Cohen)
Street and number: 565 Holly Avenue
City: St. Paul MN Zip Code: 55102 Phone number: (651) 485-1738 e-mail: craigcohen39@aol.com
Phone number: (651) 485-1738 e-mail: craigcohen39@aol.com
5. PROJECT ARCHITECT (If applicable)
Contact person: Jerry Hagen
Company: Hagen Christensen & McIlwain Architects
Street and number: 4201 Cedar Avenue South
City: Minneapolis State: MN Zin Code: 55407
City: Minneapolis State: MN Zip Code: 55407 Phone number: (612) 904-1332 Phone number: Hagen@hcmarchitects.com
6. PROJECT DESCRIPTION Completely describe ALL exterior changes being proposed for the property. Include descript affected existing exterior features and changes to architectural details such as wind doors, siding, railings, steps, trim, roof, foundation or porches. Attach specifications for dewindows, lighting and other features, if applicable, including color and material samples.
See attached continuation sheet for a description of the "core and shell" scope of work.
Total Project Value: \$7,285,171 (total project) Attach additional sheets if necessar



<u>PROJECT DESCRIPTION: Scope of Proposed Rehabilitation for "Core and Shell"</u> Improvements

The Schmidt Brewing Company Office Building is located in the Jacob Schmidt Brewing Company Historic District. In addition to the exterior, designated interior spaces include the lower-level Rathskeller (Dutch Room) and Tasting Room (Cafeteria), and the first-floor entry lobby (Reception Room) and Vault Room (General Office and Vaults). The scope of the "core and shell" work includes exterior and interior rehabilitation and preparation of interior spaces for future tenants (tenant improvement work will be submitted at a later date). The applicant proposes to rehabilitate the building into a mixed-use kitchen, café, office, and event space. Proposed rehabilitation work includes:

- Repair and cleaning of exterior masonry
- Minor repair of non-historic roofing materials
- Repair and rehabilitation of six exterior entrances
- Addition of one new exterior entrance
- Repair of historic windows and replacement of 11 non-historic windows
- Restoration of the Rathskeller (Dutch Room) and Tasting Room (Cafeteria) on the lower-level
- Restoration and preparation of the lobby (Reception Room) on the first-floor for future tenant improvements, including removal of non-historic reception furniture and signage
- Removal of non-historic signage and restoration of wood wall finishes at staircase from first floor lobby to basement level
- Preparation of Vault Room (General Office and Vaults) for future tenant use, including removal
 of non-historic finishes
- Installation of new elevator at south side of the building
- Updating of mechanical, electrical, and plumbing systems

This project will be certified for state and federal historic tax credits. The Part 1 Historic Preservation Certification application was submitted to the Minnesota State Historic Preservation Office (SHPO) on December 1, 2017. The Part 2 application was submitted to the SHPO on December 15, 2017.

Description of Scope Items:

Exterior Work

Repair and cleaning of exterior masonry (Bedford Stone and brick):

- Re-pointing and brick replacement will be limited but will occur where necessary. Joint profiles will
 be replicated where re-pointing occurs. Any replacement bricks will match the dimensions and color
 of the existing brick. Replacement masonry unit selection will be submitted to the SHPO for review
 and approval.
- Mortar mixtures will duplicate the original mortar in color and texture and will be appropriate for
 use with historic masonry. Mortar mock-ups will be submitted to the SHPO for review and approval.
- Stone finishes will be repaired where damaged, with the original style, color, and proportion of the existing stone replicated as necessary. Where stone is too damaged for repair, it will be replaced in-

kind to match the existing. Any replacement stone will be submitted to the SHPO for review and approval if needed.

- Exterior walls will be cleaned using the gentlest means possible.
 Also see attached specifications section 040120 for Maintenance of Unit Masonry.
 Repair of non-historic roofing materials:
- Selective repair of the building's TPO membrane roof (installed in 2011) will occur where needed. Roof repair and any new roof penetrations will match the current roofing system.

Repair and rehabilitation of six building entries:

- The main entry, centered on the Seventh Street elevation, currently contains a single-leaf metal
 door that is not original. The original door to this entrance has been found; it will be repaired
 and reinstalled in the existing original opening. The non-historic doorframe will be removed and
 replaced with a frame to match the original design. New hardware will be installed to meet code
 requirements. The stone trim, detailing, and original copper light fixtures at the entrance will be
 repaired and restored.
- The non-historic metal door located on the building's west elevation will be replaced with a wood frame and door with a full lite and transom. The adjacent head detail will be matched at the window.
- The wood door on the southeast (rear) elevation of the north wing will be removed and repaired. The swing will be modified to swing out to meet current building code requirements.
 A concrete landing and stair will be installed off of this entrance to exit on the east side of the building.
- The single-leaf, non-historic wood door at the west end of the building's southeast façade will be removed and replaced with a wood frame and door with a full lite. A small concrete landing and stairs will be installed to transition the entrance to the parking surface.
- The double-leaf door at the east end of the building's southeast façade will be removed and
 replaced with a single-leaf, metal frame, and door. The landing inside of the entrance will be
 extended to three feet to meet current building code requirements. New exterior walls will be
 constructed to enclose this extension. Exterior wall construction will match the adjacent
 existing walls in appearance and material.
- The entrance on the building's south façade, which contains a non-historic, single-leaf door, will be expanded and replaced with a double-leaf door. The existing ADA ramp and concrete steps will be replaced and the transom will receive a new window.

Addition of one new entrance:

One new entrance will be installed in the eastern portion of the southeast elevation to provide
access to the proposed tenant space. The new door opening will be within the width of an
existing window opening and have a transom installed above. Stairs and a landing will be
installed to connect the entrance to the parking surface.

Repair of historic windows and replacement of non-historic windows:

- The existing, historic wood windows (1/1 windows with double-hung wood sashes) will be retained and repaired as necessary. Repairs include painting and installation of insulated glazing.
- Decorative woodwork above windows on the north and west elevations will be repaired as necessary with materials that match existing.
- The 11 aluminum sash non-historic replacement windows will be removed, and new 1/1 Kolbe & Kolbe wood windows will be installed. New windows will match the existing wood windows in size, proportion, profile, and sash configuration. The finish and color will also match the historic windows.
- The fluted, stainless steel spandrel panels below windows will be repaired where possible and/or replaced in-kind where necessary.
- All window openings have non-historic storm windows. These will be removed.
- The pipe and cable rail system at the exterior window wells is deteriorated and will be removed; a new pipe and cable rail system will be installed. The pipe rail profile on the new system will replicate the existing.

See attached specifications section 085211 & 085200 regarding window repair and replacement submittal requirements.

Interior Work

See attached specification section 013591 for Historic Treatment Procedures.

Restoration of the Rathskeller (Dutch Room) and Tasting Room (Cafeteria) on the lower level:

- Work in these spaces is generally limited to repairs where needed.
- In the Rathskeller, the fiber panel ceiling finish is failing and will be replaced in kind. New ceiling tiles will mimic the appearance and pattern of the existing tiles.
- Restrooms in the Rathskeller will be reused as mechanical closets and the existing historic restroom paneled doors will be repaired and retained in place.
- New sprinklers will be installed in existing bulkheads.
- Interior masonry and woodwork repair will occur where necessary; all new materials will match the existing.
- The existing clear coating on the stone floor in the Rathskeller will be removed; a new clear finish will be applied.
- Patching and repair work of plaster walls and portions of the ceiling will be provided and will match the adjacent finish.
- In the Tasting Room, both the ceiling tiles and the flooring are in poor condition and will be removed and replaced to match existing size and pattern.

Rehabilitation and preparation of the lobby (Reception Room):

- The lobby is trimmed and wainscoted in rift-sawn oak. Originally stained dark, the casework was bleached in a 1960s remodeling. Oak trim, wainscoting, and paneling will be retained in place and repaired or replaced in-kind where necessary. The wood trim, wainscot, and paneling will be returned to its original, darker stain, which was uncovered on a section of trim near the lobby stair.
- The non-original and non-historic reception desk and associated casework in the lobby will be removed.
- Asbestos linoleum tile flooring is in poor condition due to wear over time as well as to structural shifts, which have created cracks in the material. Due to its condition and the presence of asbestos, flooring will be removed and replaced with new composite tile flooring to replicate the existing pattern, including the Schmidt logo and medallion at its current location.
- The existing ceiling tiles will be removed due to asbestos material. The ceiling will be replaced with 12" x 12" acoustical tile to match existing in size and pattern.

Repair of the staircase from first-floor lobby to lower-level:

- A stair is located in the western portion of the lobby and provides access to the Rathskeller via a small lobby at the base of the stair. The stair has undergone limited alterations since its construction. The design of the stair components are modern-inspired and the balustrade and railings are iron. Stair treads are finished in a composite tile and capped with a metal nosing.
 Wall treatments within the circulation space are finished in wainscot paneling to a mid-floor landing and plaster in the remainder of the space.
- The stone floor at the base of the stair will have its existing clear finish removed; a new clear finish will be applied.
- Metal railing and balustrade will be cleaned and remain in place.
- Wainscot paneling will be repaired where needed and replaced-in-kind where absent or beyond repair. Replacement material will match existing.
- Plaster walls on the lower portion of the stairwell will be repaired where needed.
- Existing composite tile on stair treads will be replaced due to the poor condition of the existing material. Replacement material will match the existing and the metal nosing will be retained.

Preparation of Vault Room (General Office and Vaults):

- The Vault Room, which houses Vault A, has been altered over time and is finished with non-historic flooring and wood paneling on the walls. Vault A will be retained in its current location with no changes to its appearance. Sprinkler heads will be installed in Vault A in a discrete manner to meet fire code requirements.
- Ceiling and roof joists will be inspected throughout the southwest wing (in which the Vault Room and General Office is located) to ensure structural stability. Ceiling coverings will need to


be removed to conduct inspections. New ceiling finishes will be provided in a similar 12" x 12" acoustical tile to match the existing pattern and appearance.

Installation of an elevator at the south side of the building:

- An elevator is proposed at the south side of the building to meet accessibility requirements.
- The location of the elevator was set to maximize connectivity to the existing lobby and circulation spaces on all three levels while minimizing removal of historic materials.
- The elevator shaft will be constructed primarily with CMU tied into the existing structural system. The penthouse of the shaft will extend approximately 5 feet above the existing roof and will be set back from the façade on the southeast elevation.

Updating of mechanical, electrical, and plumbing systems

- All mechanical systems are out of date and will be replaced to meet current code requirements. Existing systems are a combination of original systems and more modern systems throughout the building including boilers as well as air handlers throughout upper floors. Mechanical work will require new piping, ductwork, equipment, grilles, registers, and diffusers. Existing bulkheads and grills will be re-used whenever possible.
- Existing electrical systems are a combination of old and new technologies and materials. The
 electrical system will be updated to meet current electrical code. Historic lighting fixtures on the
 interior and exterior will remain and be restored where reparable.
- Existing plumbing system and fixtures are out of date and are in various states of condition. All fixtures in bathrooms and kitchens will be removed and replaced to meet ADA requirements. The entire building will be sprinkled utilizing a wet pipe sprinkler system for fire protection.

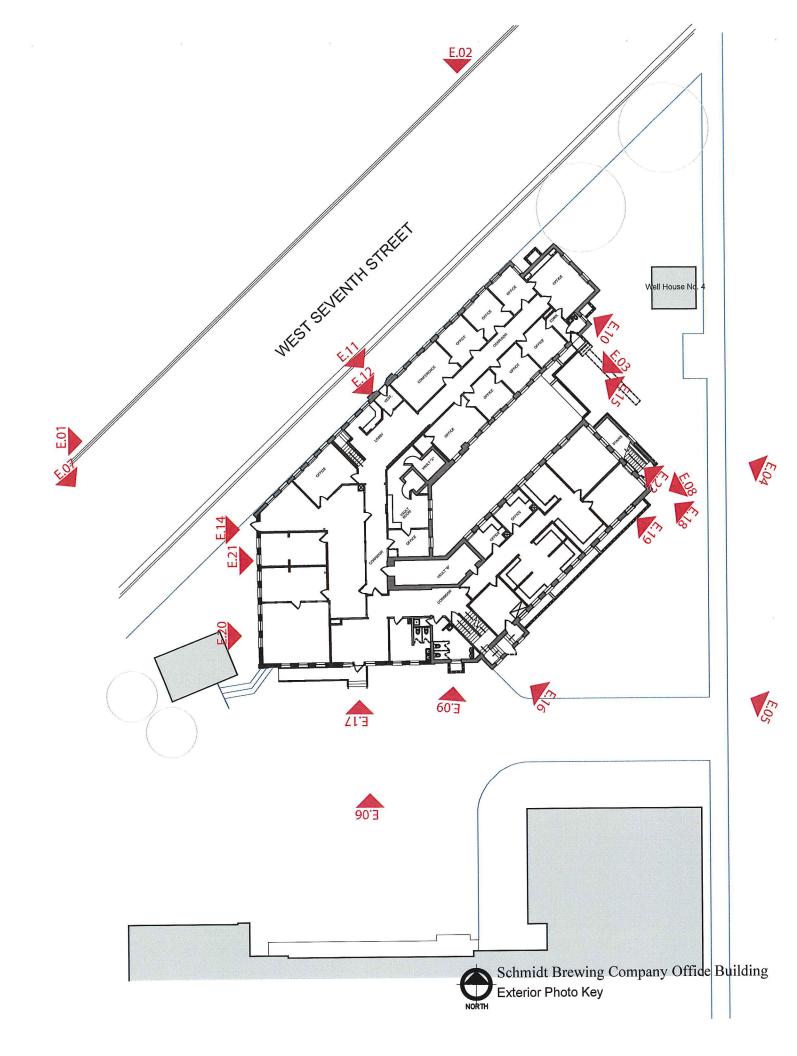



E.01 Looking northeast down West Seventh Street. North and west facades of the Office Building visible. Photo taken October 2017.




E.02 Looking southwest down West Seventh Street. North and east facades of the Office Building visible. Photo taken October 2017.



E.03 Looking between the wings of the "U" to the southwest. Photo taken October 2017.



E.04 Looking northwest from parking lot. East and southeast facades are visible. Photo taken October 2017.

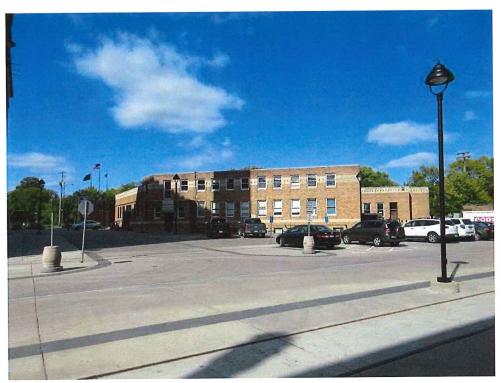


E.05 Looking to the north with the southeast façade viable. Photo taken October 2017.



E.06 Looking to the north at the south façade of the Office Building. Photo taken October 2017.




E.07 Looking to the southwest from West Seventh Street at the west façade. Photo taken October 2017.

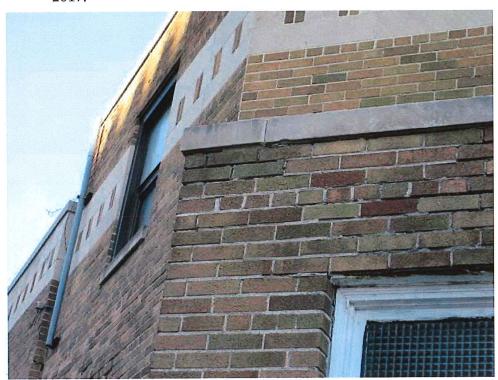


E.08 Detail photo showing masonry condition. Photo taken October 2017.



E.09 Photo of missing and damaged masonry units on southeast façade. Photo taken October 2017.

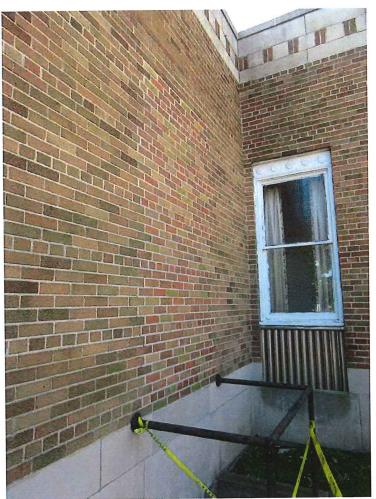

E.10 Photo showing non-historic brick infill on back façade of front portion of office building. Photo taken October 2017.

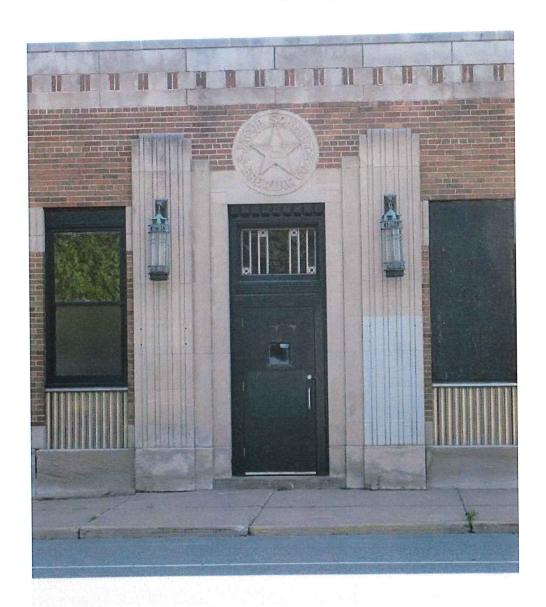


E.11 Main entrance on northwest façade off of West Seventh Street. Photo taken October 2017.




E.12 Detail of original lighting fixtures at main entrance on northwest façade. Photo taken October 2017.




E.13 Original main entrance door to be rehabilitated and reinstalled on northwest façade. Photo taken October 2017.

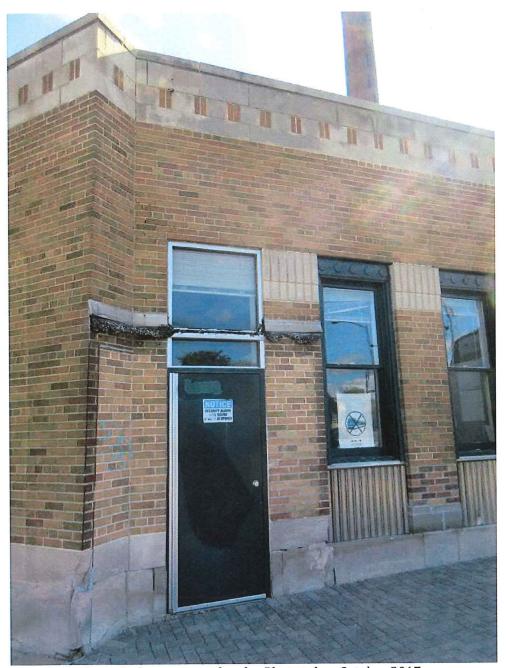

E.14 Non-historic door on west façade. Photo taken October 2017.

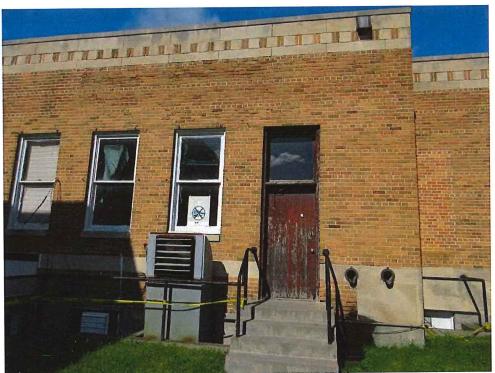


E.15 Entrance off of rear (southeast) facade of the north wing. Photo taken October 2017.

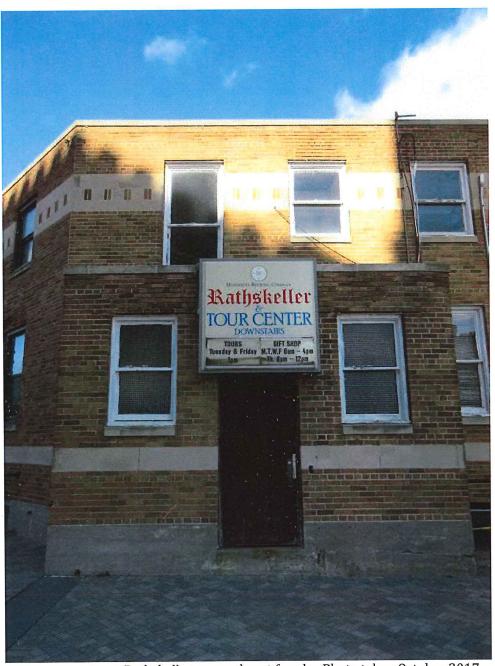

E.16 Entrance to Rathskeller on southeast façade. Photo taken October 2017.



E.17 Entrance on south façade. Photo taken October 2017.

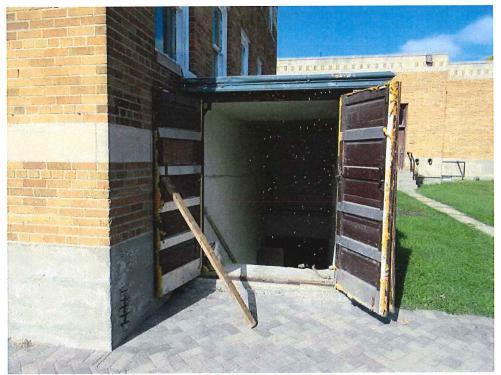

E.18 Entrance to basement on southeast facade. Location where landing will be extended and new exterior walls will be built. Photo taken October 2017.




E.19 Detail of the condition of original wood window on southeast façade. Photo taken October 2017.




E.20 Aluminum windows on west façade to be replaced. Photo taken October 2017.





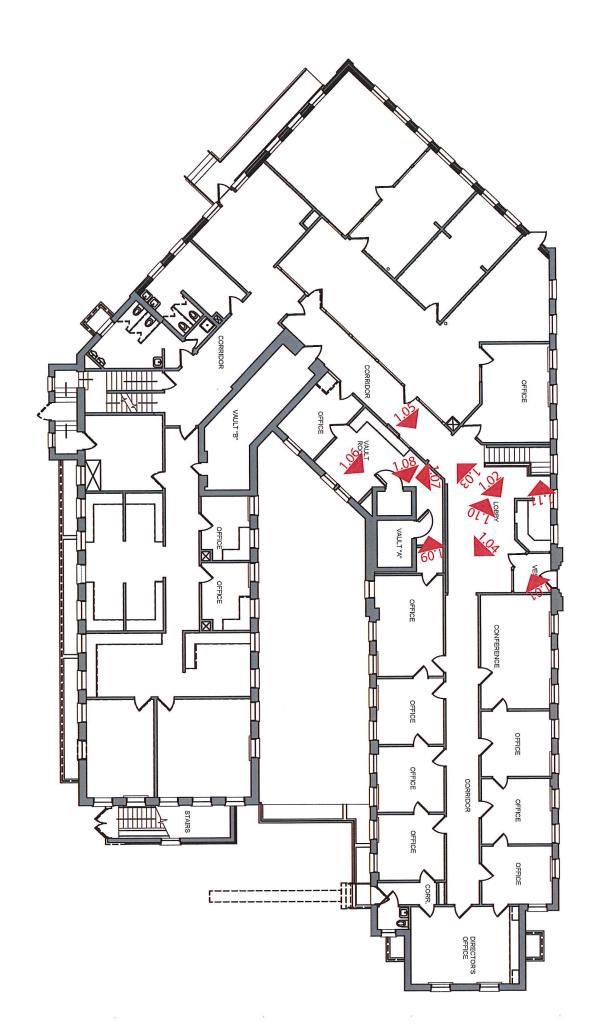


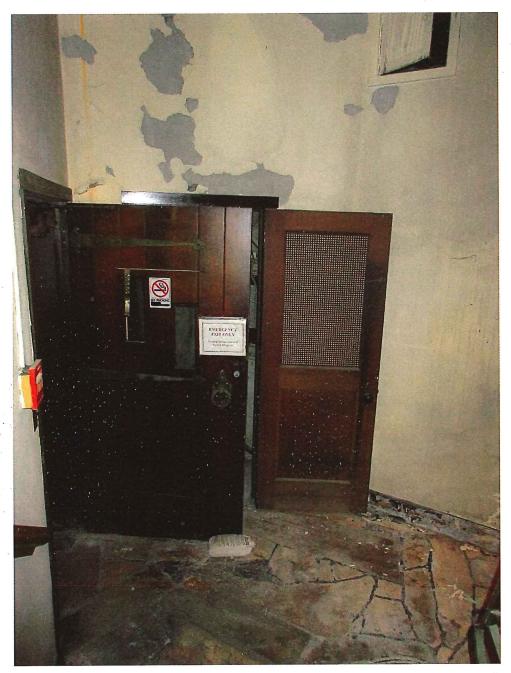

L.01 Photo of entrance to Rathskeller at the bottom of main entrance stairs. Photo taken October 2017.



L.02 Overall photo of the Rathskeller space. Photo taken October 2017.

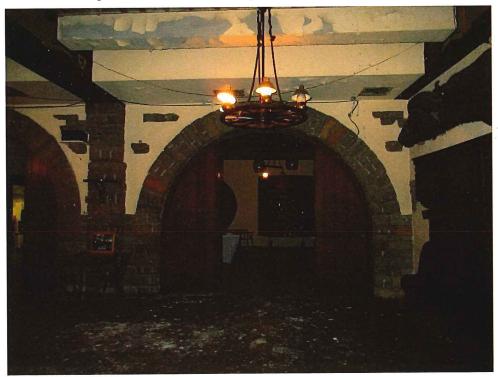


L.03 Photo of passage between Rathskeller space and tasting room. Photo taken October 2017.



L.04 Photo of northwest interior wall of Rathskeller space. Photo taken October 2017.




L.05 Photo of entrance into Rathskeller space. Photo taken October 2017.

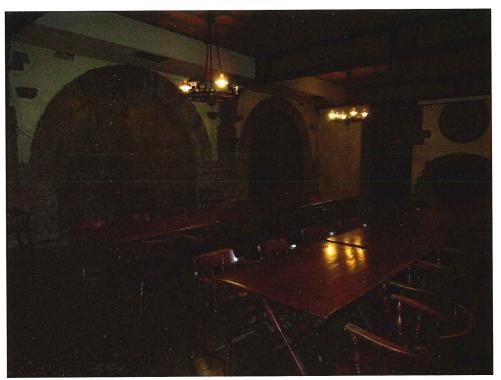


L.06 Looking towards the north corner of Rathskeller space. Photo taken October 2017.



L.07 Looking at back wall of Rathskeller with fireplace, flanked by entrances into bathrooms. Photo taken October 207.

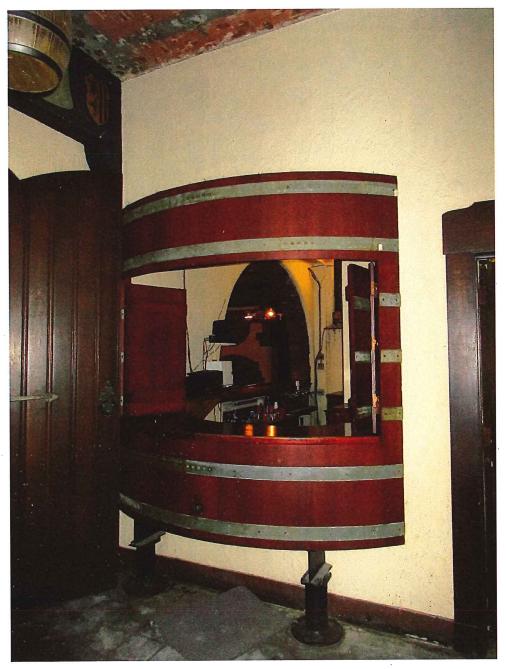


L.08 Photo of barrel shaped bar in the tasting room. Photo taken October 2017.

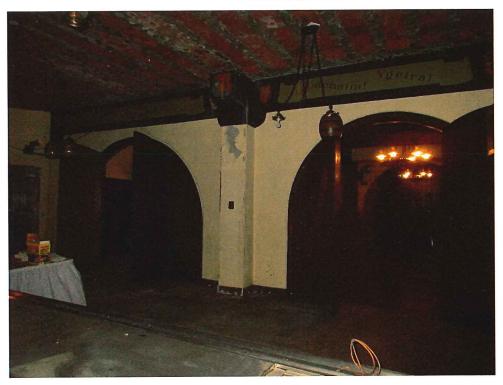

L.09 Looking from tasting room into Rathskeller. Photo taken October 2017.



L.10 Looking at barrel room décor on southeast wall of the tasting room. Photo taken October 2017.

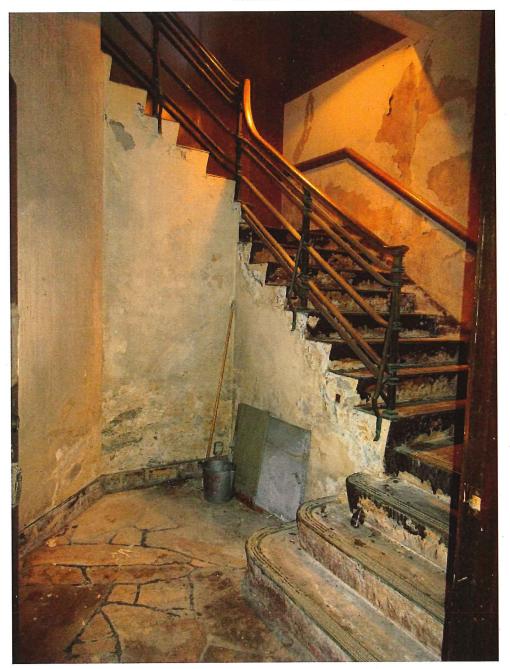

L.11 Looking up main lobby stairs from the lower level. Photo taken October 2017.




1.01 Looking in front vestibule entering into the lobby off of West Seventh Street. Photo taken October 2017.




1.02 Photo of main lobby off of West Seventh Street. Photo taken October 2017.




1.03 Looking south down corridor into southwest wing. Photo taken October 2017.

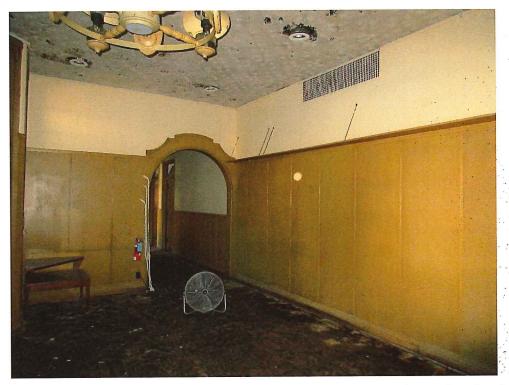


1.04 Looking east down corridor into north wing from lobby. Photo taken October 2017.

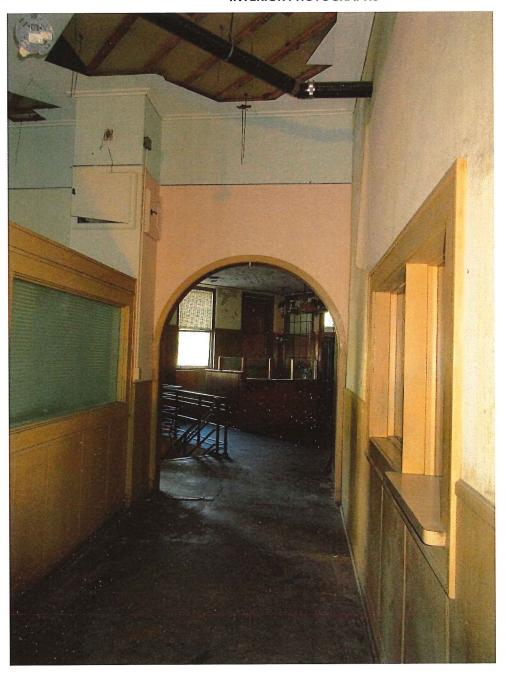

1.05 Looking into main lobby off of corridor from the southwest wing. Photo taken October 2017.

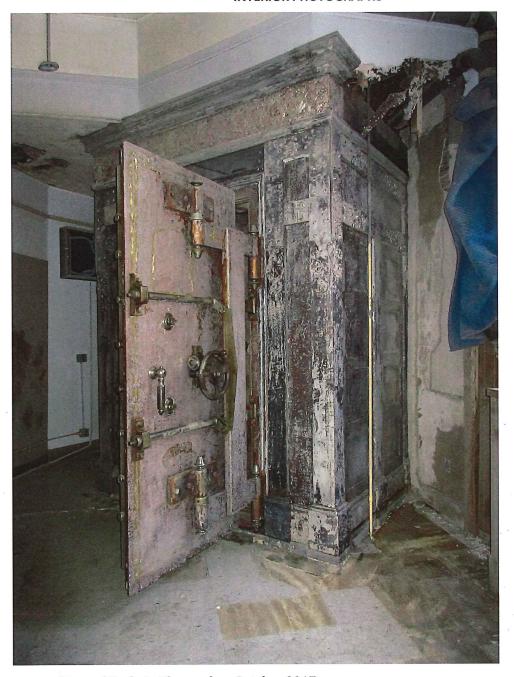


1.06 View of Vault A. Photo taken October 2017.

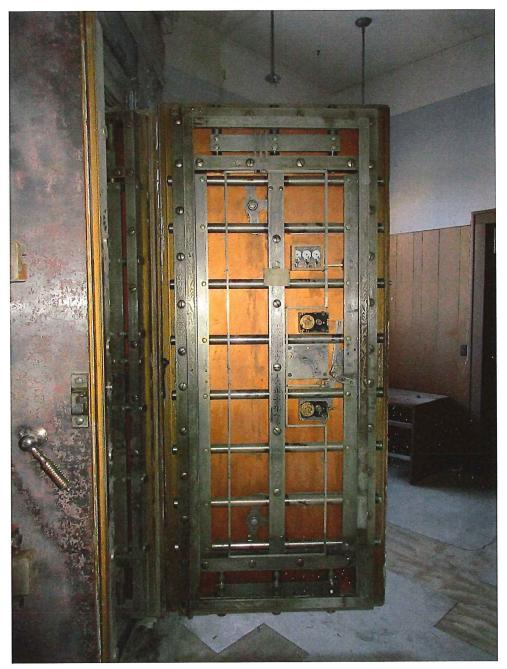

1.07 Looking at rear side of Vault A door. Photo taken October 2017.




1.08 Detail photo of Vault A. Photo taken October 2017.

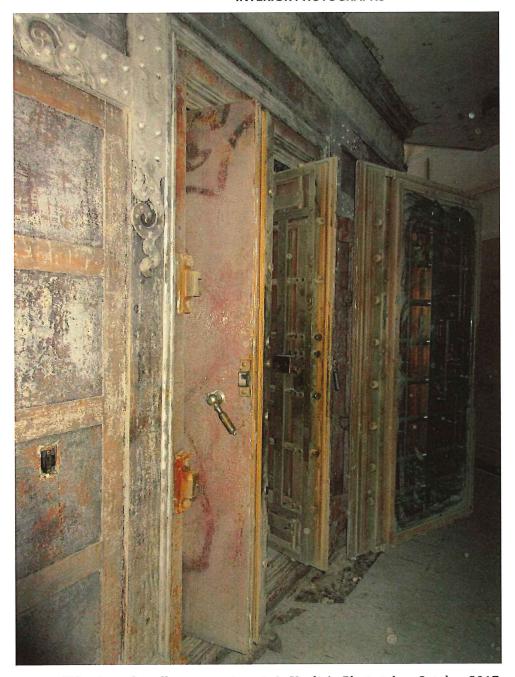


1.09 Side view of smaller compartments in Vault A. Photo taken October 2017.




1.10 View of lobby stair. Photo taken October 2017.

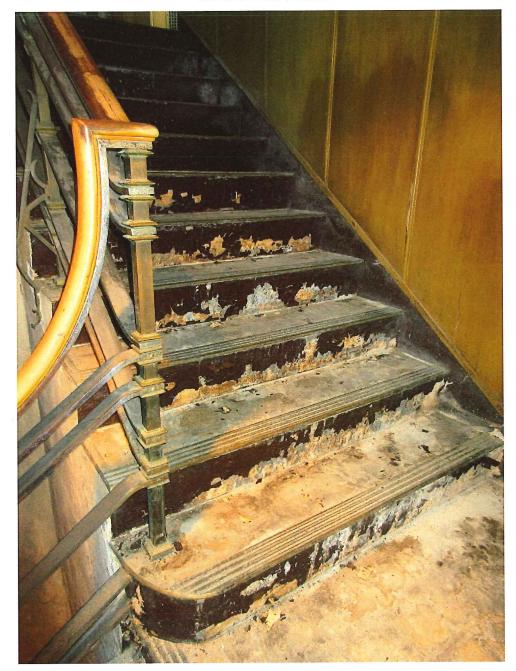

1.11 View of lobby stair at landing between first and second floors. Photo taken October 2017.

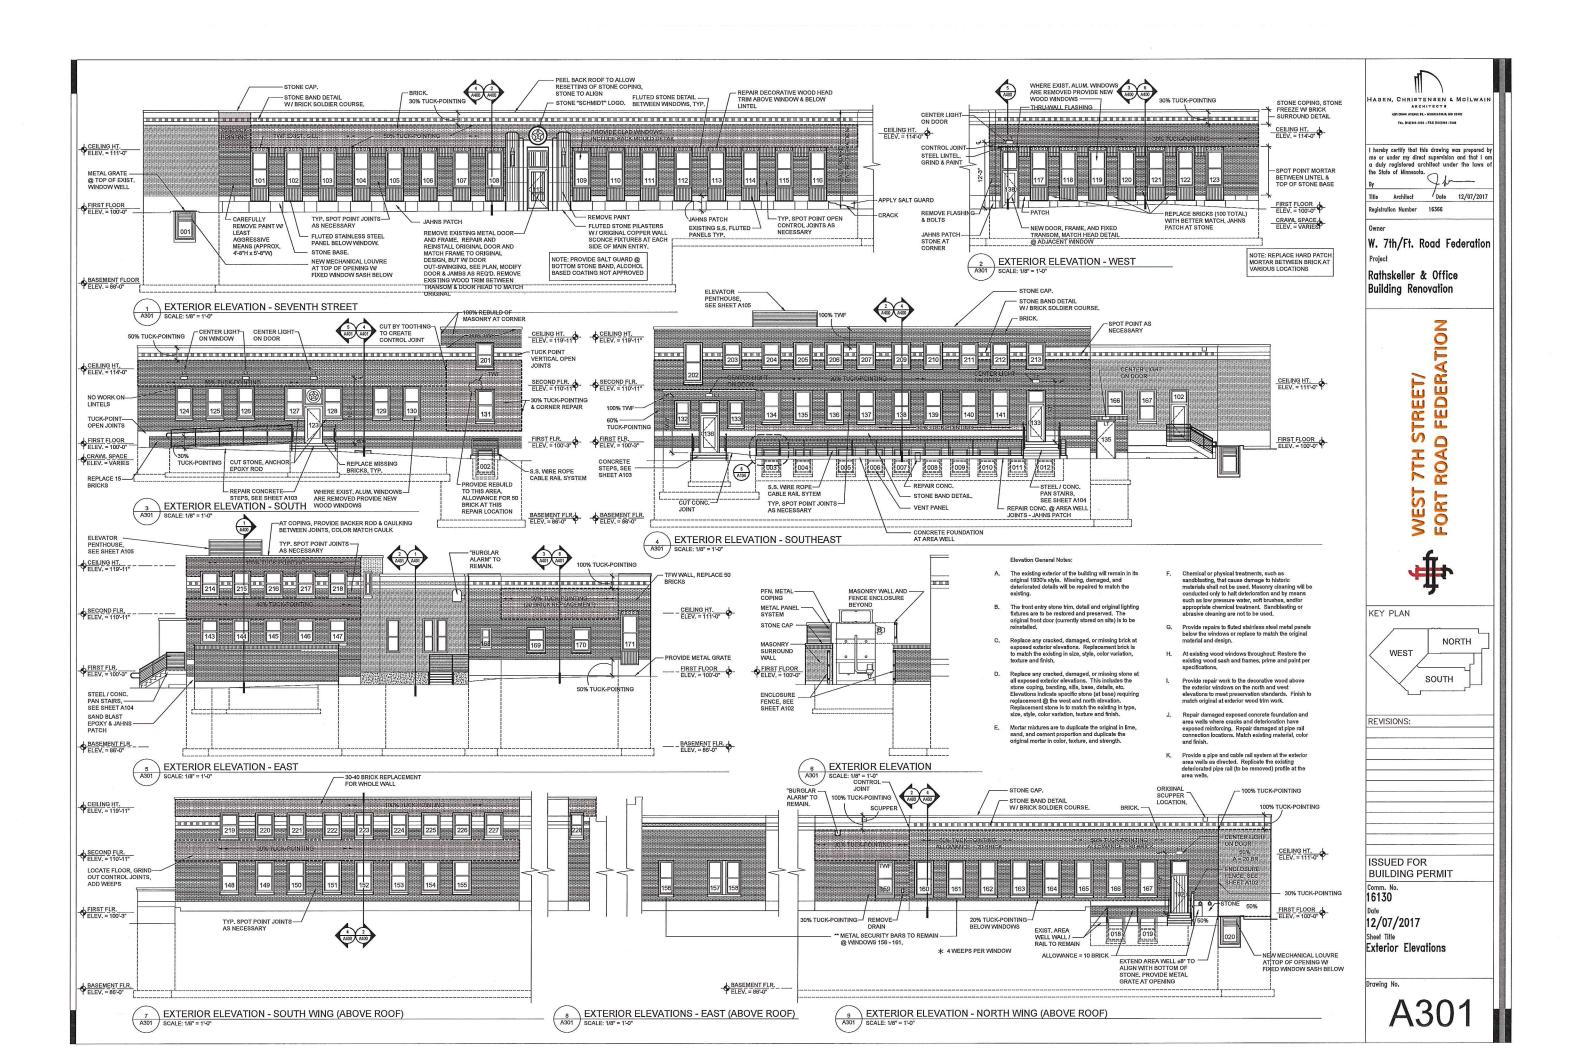

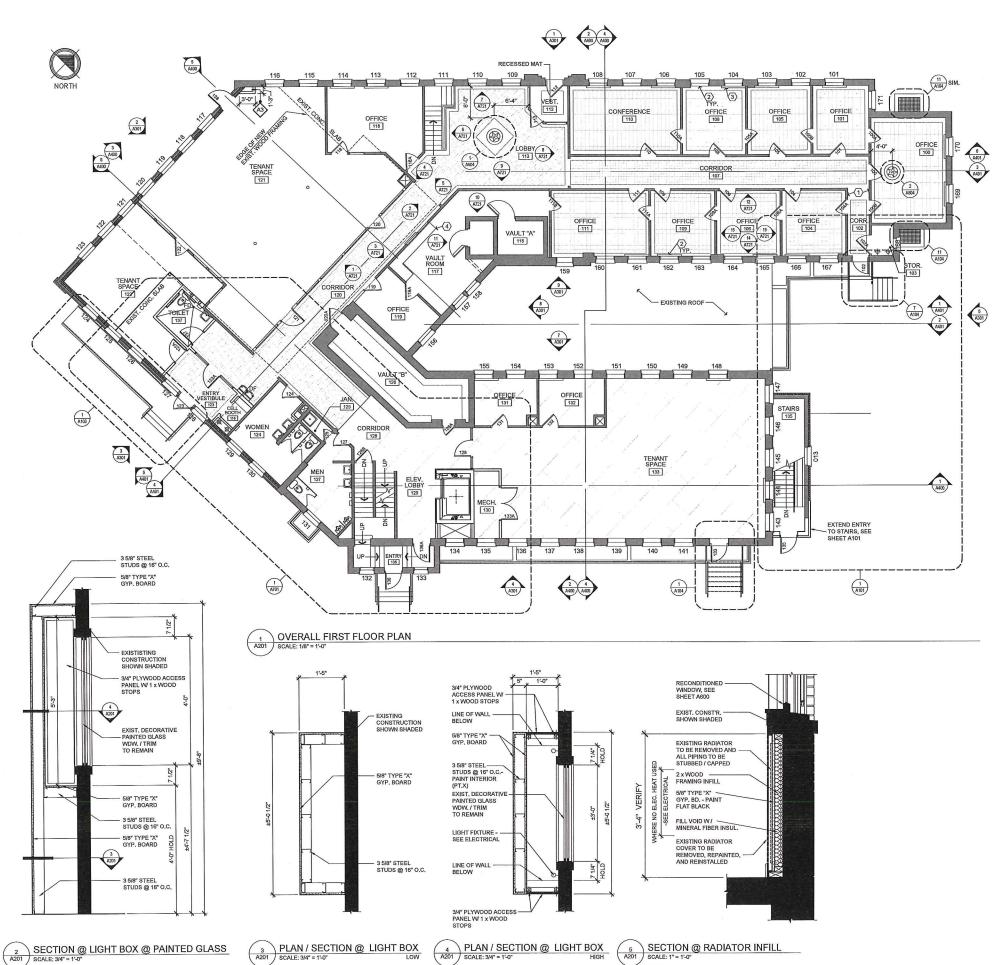



GENERAL NOTES: FIRST FLOOR

- A. Much of the wood roof and floor framing in the western side of the building is undersized and failing to some degree. This area is built over part of an older building and reuses some of the existing foundations. It is intended that this portion of the structure will be repaired as part of this project. Some work has already been undortaken See Structure.
- Provide additional support for floor joists at east end of the crawl space as outlined in the plans and structural drawings.
- Provide insulation at the first floor exterior framed wall that runs from the Women's Room # 124 going to the west, and the west exterior wall going north to the public sidewalk. Insulate from floor to underside of roof.
- In the corridor in the west wing replace with new composite tile flooring to replicating the existing pattern.
- In the north wing replace the flooring with new composite tile flooring replicating the existing pattern. This includes the two locations with the Schmidt logo.
- At the south wing first and second floors repair the existing terrazzo floors. This includes the stairway from the first to the second floor. Provide repair per specifications.
- Interior Doors: Wherever possible, historic paneled doors (and hardware) will be repaired rather than replaced. If replacement of original or historic doors is necessary, the replacement will duplicate or be compatible with the material, design, and hardware of the older. See door schedule.
- Windows: Provide repairs to existing original wood windows throughout. Replace existing newer anodized aluminum windows at west and south elevations with new wood windows to match original profile. At new windows match existing original masonry openings.
- J. Repair and refinish existing wood trim, wainscot, and paneling where it is to remain and is in serviceable condition. Where missing or in need of being replaced provide new wood trim and paneling to match. Final wood finishing is to reflect the original darker finish prior to the blonding of the facility in the 1900's -Verify sample area with owner/architect.
- Provide patching and repair work as needed at existing plaster walls and ceilings that remain.
- Provide new acoustical tile ceilings at locations indicated in ceiling plan
- Provide one Hydraulic Passenger Elevator to serve all three floors per drawings and specifications -See sheet A500.
- Repair concrete walls where damaged and reinforcing has been exposed.
- Provide new railings at area wells to match the original diameter. Provide additional vertical supports and cable rail infill as indicated on the drawings.
- Q. For finishes, see sheet A203.

KEY NOTES: FIRST FLOOR

- Provide wainscot infill to match existing adjacent.
- Existing radiator cover to be removed, repainted, & reinstalled -typ. north wing.
- Provide new radiator cover at existing opening (cover missing) to match existing adjacent.
- Provide new oak transaction counter top to replace demolished plastic laminate counter top.



TEL (012)104-1232 - FAX (012) 814 -7244

I hereby certify that this drawing was prepared by me or under my direct supervision and that I am a duly registered architect under the laws of

Title Architect Date 12/07/2017 Registration Number 16366

W. 7th/Ft. Road Federation

Rathskeller & Office **Building Renovation**

> **FEDERATION** STREET/ ROAD H WEST FORT



/	,	NORT	Ή.
	WEST		刀
\	\checkmark	SOUTH	

REVISIONS:


ISSUED FOR **BUILDING PERMIT**

Comm. No 16130 12/07/2017 Sheet Title Overall First Floor Plan

Drawing No.

PLAN / SECTION @ LIGHT BOX
A201 SCALE: 3/4" = 1'-0" HIGH

5 SECTION @ RADIATOR INFILL
SCALE: 1" = 1'-0"

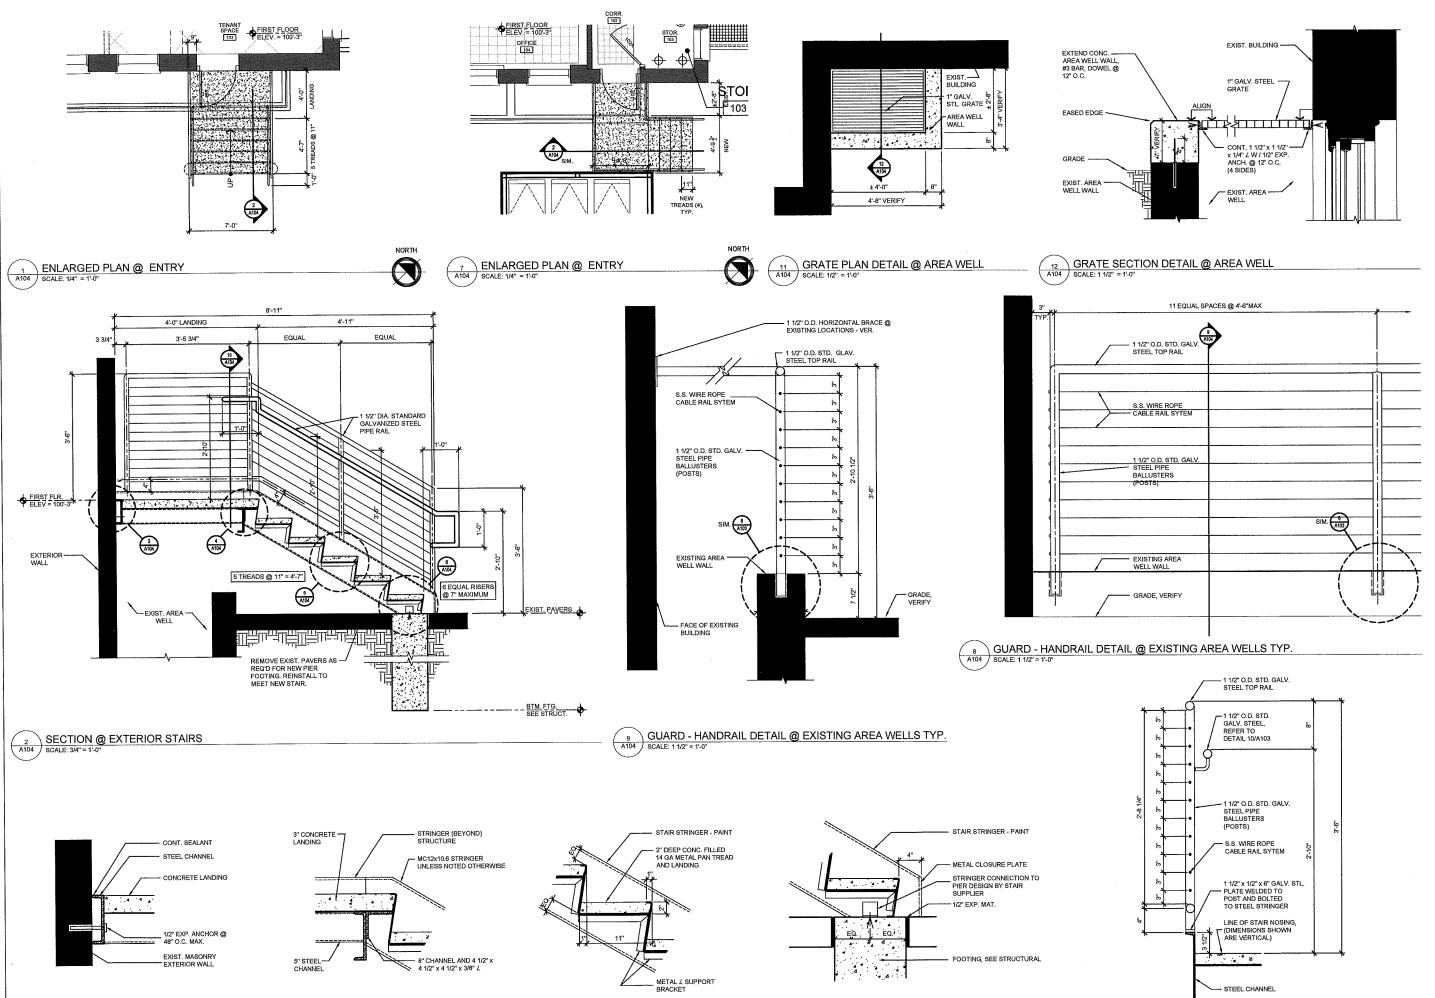

HAGEN, CHRISTENSEN & ARCHITECTS AMERICAN AMERICA

I hereby certify that this drawing me or under my direct supervision a duly registered architect und the State of Minnesota.

Title Architect Date
Registration Number 16366

Owner

W. 7th/Ft. Road Fo

Rathskeller & Offic Building Renovation

ilding Renovation

WEST 7TH STREET/ FORT ROAD FEDERATION



KEY PLAN




REVISIONS:

ISSUED FOR
BUILDING PERMIT
Comm. No.
16130
Date

Date
12/07/2017
Sheet Title
Enlarged Plans /

Details

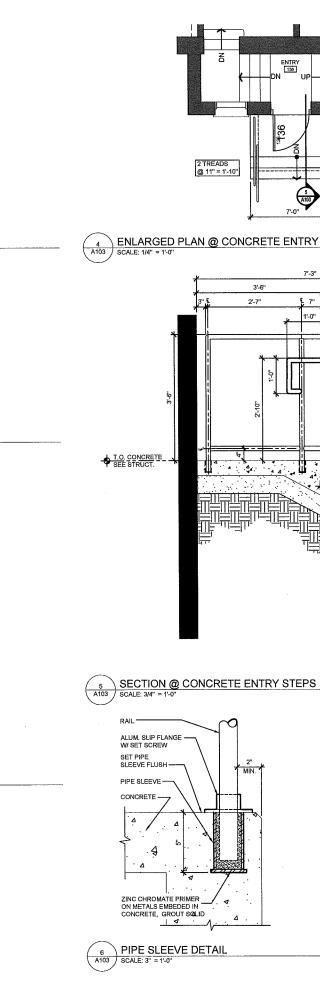

(1) NOT USED

NOT USED NOT USED

(3) NOT USED

SECTION VIEW

STEEL HANDRAIL DETAIL
SCALE: 3" = 1'-0"

- RETURN END TO POST AND CAP

1 1/2" STD. GALV. STEEL-


1/2" ROUND BENT STEEL -

ROD BRACKET - WELD TO POST AND HANDRAIL - PAINT

ISOMETRIC N.T.S.

2 TREADS @ 11" = 1'-10"

3'-6" 2'-7"

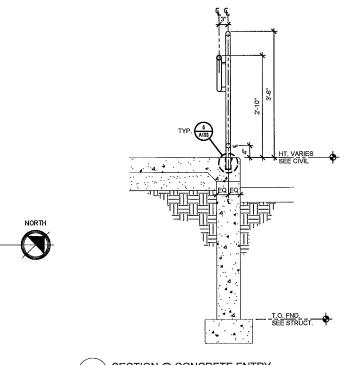

8 A104

3 EQUAL RISERS @ 7" MAXIMUM

T.O. FND. SEE STRUCT.

DASHED LINE INDICATES VERTICAL STAIR / RAMP
POST - SET 4" INTO SLEEVE
AND FILL W/ NON SHRINK
GROUT

- 2 1/2" GALV. STEEL PIPE, WELD TO 1/4" PLATE

EMBED SLEEVE IN CONCRETE

 $\frac{\text{ISOMETRIC}}{\text{N.T.S.}}$

7 SECTION @ CONCRETE ENTRY
A103 SCALE: 3/4" = 1'-0"

(8) NOT USED

WEST SOUTH

ISSUED FOR BUILDING PERMIT

Comm. No. 16130

12/07/2017

Enlarged Plans /

Drawing No.

AAGEN, CHRISTENSEN ARCHITECTS I hereby certify that this drawing me or under my direct supervisio a duly registered architect und the State of Minnesota.

W. 7th/Ft. Road F

Rathskeller & Offic **Building Renovation**

WEST 7TH STREET/ FORT ROAD FEDERATION

KEY PLAN

REVISIONS:

Details

WDW DPNG.	LOCATION	WDW TYPE	OPNG. WIDTH	OPNG. HEIGHT	MAT	INTERIOR FINISH	NOTES
001	1/A301	4	31-6"	5'-2"	NA	NA	Remove frame and provide louver.
002	3/A301	1 Existing	3'-6"	5'-2"	Wood	Paint	Replace broken or missing glass with obscure to match original.
003	4/A301	1 Existing	3'-6"	5'-2"	Wood	Paint	Replace broken or missing glass with obscure to match original.
004	4/A301	1 Existing	3'-6"	5'-2"	Wood	Paint	Replace broken or missing glass with obscure to match original.
005	4/A301	1 Existing	3'-6"	5'-2"	Wood	Paint	Replace broken or missing glass with obscure to match original.
006	4/A301	1 Existing	3'-6"	5'-2"	Wood	Paint	Provide clear glass both sash.
007	4/A301	1 Existing	3'-6"	5'-2"	Wood	Paint	Provide clear glass both sash.
800	4/A301	1 Existing	3'-6"	5'-2"	Wood	Paint	Provide clear glass both sash.
009	4/A301	1 Existing	3'-6"	5'-2"	Wood	Paint	Provide clear glass both sash.
010	4/A301	1 Existing	3'-6"	5'-2"	Wood	Paint	Provide clear glass both sash.
011	4/A301	1 Existing	3'-6"	5'-2"	Wood	Paint	Provide clear glass both sash.
012	4/A301	1 Existing	3'-6"	5'-2"	Wood	Paint	Provide clear glass both sash.
013	1/A102	1 Existing	3'-6"	5'-2"	Wood	Paint	Replace broken or missing glass with obscure to match original.
014	5/A300	1 Existing	3'-6"	4'-10"	Wood	Paint	Replace broken or missing glass with obscure to match original.
015	5/A300	1 Existing	3'-6"	4'-10"	Wood	Paint	Replace broken or missing glass with obscure to match original.
016	5/A300	1 Existing	3'-6"	4'-10"	Wood	Paint	Replace broken or missing glass with obscure to match original.
017	5/A300	1 Existing	3'-6"	4'-10"	Wood	Dark Stain	Replace broken or missing glass with obscure to match original.
018	9/A301	1 Existing	3'-6"	5'-2"	Wood	Dark Stain	Replace broken or missing glass with obscure to match original.
019	9/A301	1 Existing	3'-6"	5'-2"	Wood	Dark Stain	Replace broken or missing glass with obscure to match original.
020	9/A301	4	3'-6"	5'-2"	NA	NA	Remove frame and provide louver.


WDW :	LOCATION	TYPE	OPNG. WIDTH	OPNG. HEIGHT	MAT	INTERIOR FINISH	NOTES
101	1/A301	3 Existing	3'-6"	6'-10"	Wood	Dark Stain	Lower sash obscure
102	1/A301	3 Existing	3'-6"	6'-10"	Wood	Dark Stain	Lower sash obscure
103	1/A301	3 Existing	3'-6"	6'-10"	Wood	Dark Stain	Lower sash obscure
104	1/A301	3 Existing	3'-6"	6'-10"	Wood	Dark Stain	Lower sash obscure
105	1/A301	3 Existing	3'-6"	6'-10"	Wood	Dark Stain	Lower sash obscure
106	1/A301	3 Existing	3'-6"	6'-10"	Wood	Dark Stain	Lower sash obscure
107	1/A301	3 Existing	3'-6"	6'-10"	Wood	Dark Stain	Lower sash obscure
108	1/A301	3 Existing	3'-6"	6'-10"	Wood	Dark Stain	Lower sash obscure
109	1/A301	3 Existing	3'-6"	6'-10"	Wood	Dark Stain	Lower sash obscure
110	1/A301	3 Existing	3'-6"	6'-10"	Wood	Dark Stain	Lower sash obscure
111	1/A301	3 Existing	3'-6"	6'-10"	Wood	Dark Stain	Lower sash obscure
112	1/A301	3 Existing	3'-6"	6'-10"	Wood	Dark Stain	Lower sash obscure
113	1/A301	3 Existing	3'-6"	6'-10"	Wood	Dark Stain	Lower sash obscure
114	1/A301	3 Existing	3'-6"	6'-10"	Wood	Dark Stain	Lower sash obscure
115	1/A301	3 Existing	3'-6"	6'-10"	Wood	Dark Stain	
116	1/A301	3 Existing	3'-6"	6'-10"	Wood	Dark Stain	
117	2/A301	3 Existing	3'-4"	6'-10"	Wood	Dark Stain	
118	2/A301	3 Existing	3'-4"	6'-10"	Wood	Dark Stein	
119	2/A301	3 Existing	3'-4"	6'-10"	Wood	Dark Stain	
120	2/A301	3 Existing	31-4"	6'-10"	Wood	Dark Stain	
121	2/A301	3 New	3'-4"	6'-10"	Wood	Dark Stain	Remove existing aluminum window unit.
122	2/A301	3 New	3'-4"	6'-10"	Wood	Dark Stain	Remove existing aluminum window unit.
123	2/A301	3 New	31-4"	6'-10"	Wood	Dark Stain	Remove existing aluminum window unit.
124	3/A301	1 New	3'-4"	6'-0"	Wood	Dark Stain	Remove existing aluminum window unit.
125	3/A301	1 New	3'-4"	6'-0"	Wood	Dark Stain	Remove existing aluminum window unit.
126	3/A301	1 New	3'-4"	6'-0"	Wood	Dark Stain	Remove existing aluminum window unit.
127	3/A301	1 New	3,-0,,	6'-0"	Wood	Dark Stain	Remove existing aluminum window unit.
128	3/A 301	1 New	3'-0"	6'-0"	Wood	Dark Stain	Remove existing aluminum window unit.
129	3/A301	1 New	31-4"	6'-0"	Wood	Paint	Remove existing aluminum window unit.
130	3/A301	1 New	3'-4"	6'-0"	Wood	Paint	Remove existing aluminum window unit.
131	3/A301	1 New	3'-8"	6'-2"	Wood	Paint	Remove existing aluminum window unit.
132	4/A301	1 Existing	3'-0"	4'-10"	Wood	Dark Stain	
133	4/A301	1 Existing	3'-0"	4'-10"	Wood	Dark Stain	
134	4/A301	1 Existing	3'-6"	6'-2"	Wood	Paint	
135	4/A301	1 Existing	31-6"	6'-2"	Wood	Paint	
136	4/A301	1 Existing	3'-6"	6'-2"	Wood	Paint	

WIND	OW SCHED	DLL. I HAC					
WDW OPNG.	LOCATION	WDW TYPE	OPNG. WIDTH	OPNG. HEIGHT	MAT	INTERIOR FINISH	NOTES
137	4/A301	1 Existing	3'-6"	6'-2"	Wood	Paint	
138	4/A301	1 Existing	3'-6"	6'-2"	Wood	Paint	
139	4/A301	1 Existing	3'-6"	6'-2"	Wood	Paint	
140	4/A301	1 Existing	3'-6"	6'-2"	Wood	Paint	
141	4/A301	1 Existing	3'-6"	6'-2"	Wood	Paint	
142	NA	NA	NA	NA	NA	NA.	Remove existing window and provide new door opening.
143	5/A301	1 Existing	3'-6"	5'-0"	Wood	Paint	
144	5/A301	1 Existing	3'-6"	5'-0"	Wood	Paint	
145	5/A301	1 Existing	3'-6"	5'-0"	Wood	Paint	
146	5/A301	1 Existing	3'-6"	5'-0"	Wood	Paint	
147	5/A301	1 Existing	3'-6"	5'-0"	Wood	Paint	
148	7/A301	1 Existing	3'-6"	6'-2"	Wood	Paint	
149	7/A301	1 Existing	3'-6"	6'-2"	Wood	Paint	
150	7/A301	1 Existing	3'-6"	6'-2"	Wood	Paint	
151	7/A301	1 Existing	3'-6"	6'-2"	Wood	Paint	
152	7/A301	1 Existing	3'-6"	6'-2"	Wood	Paint	
153	7/A301	1 Existing	3'-6"	6'-2"	Wood	Paint	
154	7/A301	1 Existing	3'-6"	6'-2"	Wood	Paint	
155	7/A301	1 Existing	3'-6"	6'-2"	Wood	Paint	
156	8/A301	1 Existing	3'-4"	7'-2"	Wood	Dark Stain	
157	8/A301	1 Existing	3'-6"	7'-2"	Wood	Dark Stain	
158	8/A301	1 Existing	3'-6"	7'-2"	Wood	Dark Stain	
159	9/A301	1 Existing	3'-0"	6'-10"	Wood	Dark Stain	
160	9/A301	1 Existing	3'-6"	6'-10"	Wood	Dark Stain	
161	9/A301	1 Existing	3'-6"	6'-10"	Wood	Dark Stain	
162	9/A301	1 Existing	3'-6"	6'-10"	Wood	Dark Stain	
163	9/A301	1 Existing	3'+6"	6'-10"	Wood	Dark Stain	
164	9/A301	1 Existing	3'-6"	6'-10"	Wood	Dark Stain	
165	9/A301	1 Existing	3'-6"	6'-10"	Wood	Dark Stain	
166	9/A301	1 Existing	3'-6"	6'-10"	Wood	Dark Stain	
167	9/A301	1 Existing	3'-6"	6'-10"	Wood	Dark Stain	
168	5/A301	1 Existing	2'-2"	4'-2"	Wood	Paint	
169	5/A301	1 New	3'-6"	6'-10"	Wood	Dark Stain	
170	5/A301	1 New	3'-6"	6'-10"	Wood	Dark Stain	
171	5/A301	3 Existing	3'-6"	6'-10"	Wood	Dark Stain	Upper sash obscure

WDW DPNG.	LOCATION	WDW TYPE	OPNG. WIDTH	OPNG. HEIGHT	MAT	INTERIOR FINISH	NOTES
201	3/A301	1 Existing	3'-6"	4"-10"	Wood	Paint	
202	4/A301	1 Existing	3'-6"	7'-10""	Wood	Paint	
203	4/A301	1 Existing	3'-6"	4'-10"	Wood	Paint	
204	4/A301	1 Existing	3'-6"	4'-10"	Wood	Paint	
205	4/A301	1 Existing	3'-6"	4'-10"	Wood	Paint	
206	4/A301	1 Existing	3'-6"	4'-10"	Wood	Dark Stain	
207	4/A301	1 Existing	3'-6"	4'-10"	Wood	Dark Stain	
208	4/A301	1 Existing	3'-6"	4'-10"	Wood	Dark Stain	
209	4/A301	1 Existing	3'-6"	4'-10"	Wood	Dark Stain	
210	4/A301	1 Existing	3'-6"	4'-10"	Wood	Dark Stain	
211	4/A301	1 Existing	3'-6"	4'-10"	Wood	Dark Stain	
212	4/A301	1 Existing	3'-6"	4'-10"	Wood	Dark Stain	
213	4/A301	1 Existing	3'-6"	4'-10"	Wood	Dark Stain	
214	5/A301	1 Existing	3'-6"	4'-10"	Wood	Dark Stain	
215	5/A301	1 Existing	3'-6"	4'-10"	Wood	Dark Stain	
216	5/A301	1 Existing	3'-6"	4'-10"	Wood	Dark Stain	
217	5/A301	1 Existing	3'-6"	4'-10"	Wood	Dark Stain	
218	5/A301	1 Existing	3'-6"	4'-10"	Wood	Dark Stain	
219	7/A301	1 Existing	3'-6"	4'-10"	Wood	Dark Stain	
220	7/A301	1 Existing	3'-6"	4'-10"	Wood	Dark Stain	
221	7/A301	1 Existing	3'-6"	4'-10"	Wood	Dark Stain	
222	7/A301	1 Existing	3'-6"	4'-10"	Wood	Dark Stain	
223	7/A301	1 Existing	3'-6"	4'-10"	Wood	Dark Stain	
224	7/A301	1 Existing	3'-6"	4'-10"	Wood	Dark Stain	
225	7/A301	1 Existing	3'-6"	4'-10"	Wood	Dark Stain	
226	7/A301	1 Existing	3'-6"	4'-10"	Wood	Dark Stain	

- Contractor is responsible to field verify all existing window openings prior to ordering material. Sizes on schedule are approximate.
- C. Replace existing newer anodized aluminum windows at west and south elevations with new wood windows to match original profile. New windows are match existing original masonry openings.
- The size and number of panes of glass in each sash are to match the original windows unless noted otherwise. Match original finish and color on the exterior.
- All existing aluminum clad windows are to be replaced. Provide new wood windows to match the original window design and profile.
- F. Match obscure glass to existing -verify.




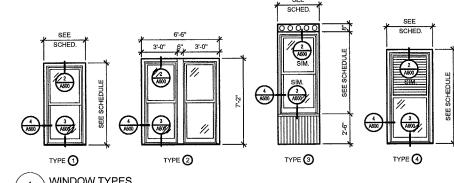


1 WINDOW TYPES SCALE: 1/4" = 1'-0" VERIFY EXISTING CONSTRUCTION SHOWN SHADED - VERIFY EXISTING CONDITIONS @ EACH NEW EXTERIOR DOOR LOCATION TREAT LINTELS W/ RUST— CONVERTER (SUCH AS PERMATEX) PAINT (W/ OIL-BASED PAINT) BACKER ROD AND SEALANT

TYPICAL EXTERIOR WINDOW DETAIL - HEAD SCALE: 3" = 1.0"

DIMENSIONS FOR REFERENCE ONLY -VERIFY EXISTING

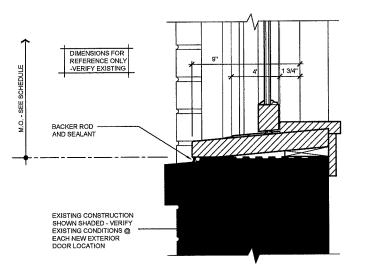

TYPICAL EXTERIOR WINDOW DETAIL - SILL SILL SILL: 3" = 1'.0"

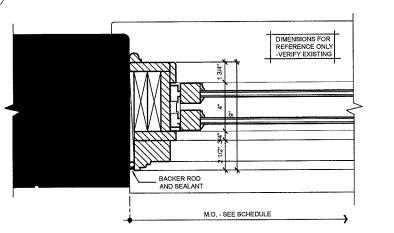

HAGEN, CHRISTENSEN & TEL (611)961-1992 - FAX (613)984-7

I hereby certify that this drawing me or under my direct supervision a duly registered architect und the State of Minnesota.

By Title Architect Date Registration Number

Owner

W. 7th/Ft. Road F

Rathskeller & Offic **Building Renovation**

WEST 7TH STREET/ FORT ROAD FEDERATION




KEY PLAN





REVISIONS:

ISSUED FOR BUILDING PERMIT


Comm. No. 16130 12/07/2017 Sheet Title
WDW. Schedules / Types / Details

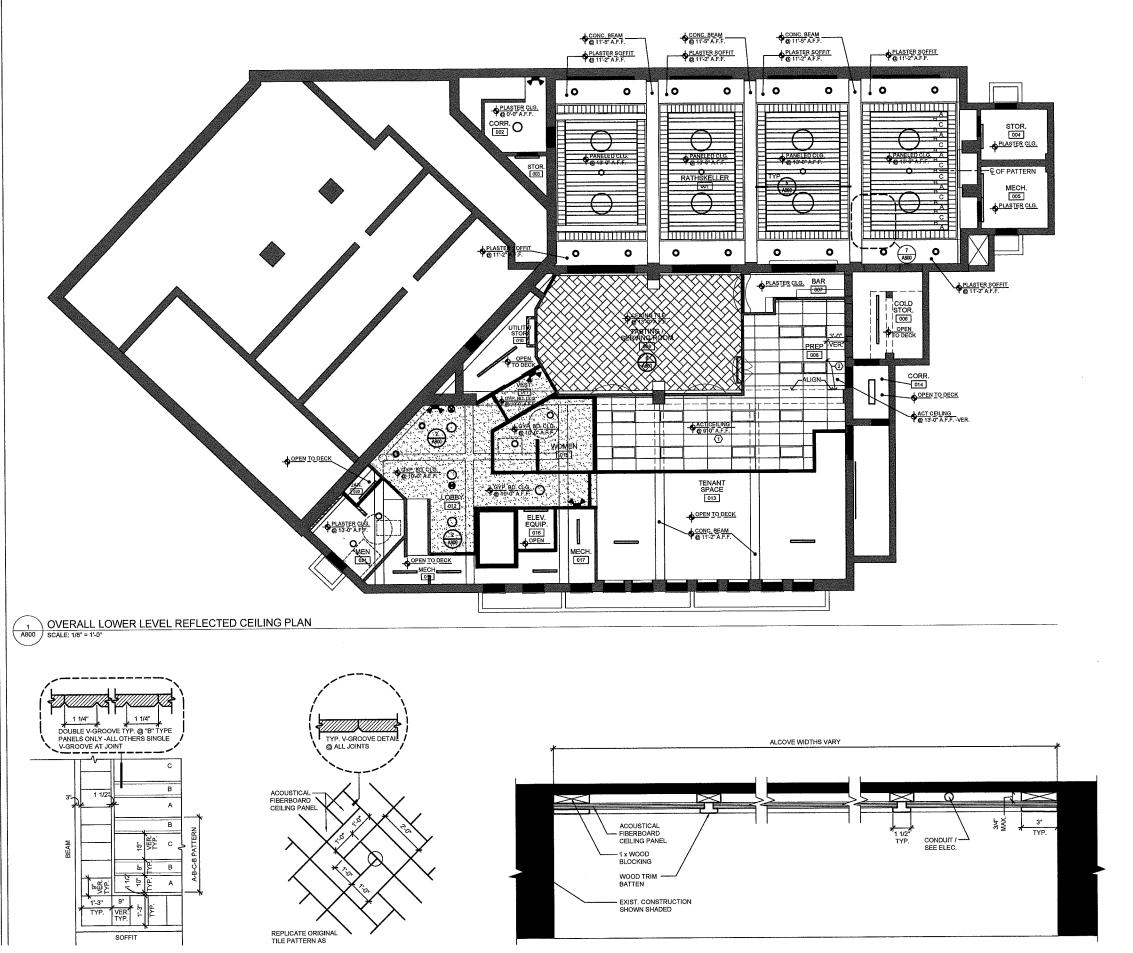

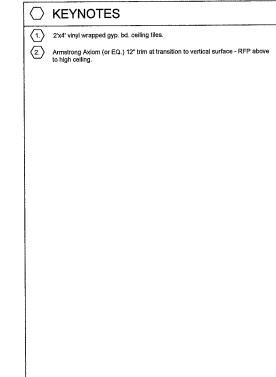

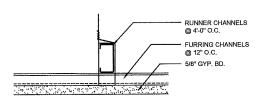



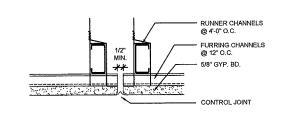



HAGEN, CHRISTENSEN & ARCHITECTS
CHICKON ARRIVES & MIRESAMUL ME
TA DISSIPATION TAX (MIRESAMUL)

I hereby certify that this drawing a me or under my direct supervision a duly registered architect und the State of Minnesota.

By

Title Architect Date

Title Architect /
Registration Number 16

er

W. 7th/Ft. Road For Project

Rathskeller & Offic Building Renovation

> WEST 7TH STREET/ FORT ROAD FEDERATION




WEST NO SOUTH

KEY PLAN


REVISIONS:

ISSUED FOR
BUILDING PERMIT
Comm. No.
16130
Date
12/07/2017


Lower Level Reflect Ceiling Plan

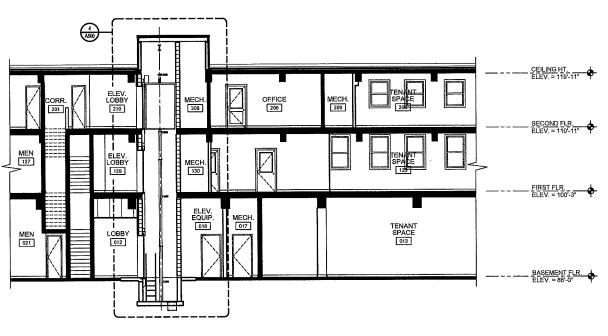

BUILDING SECTION (1 A400) SCALE: 1/8" = 1'-0"

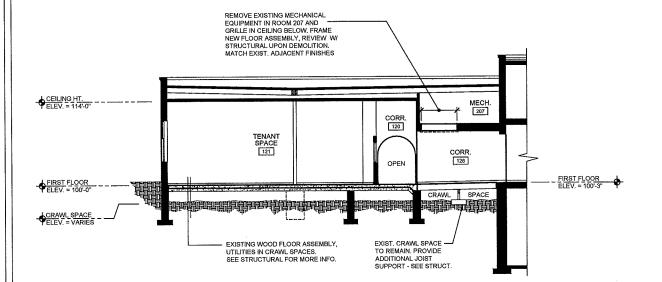


BUILDING SECTION

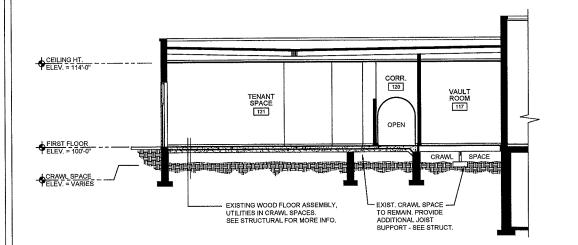




BUILDING SECTION A400

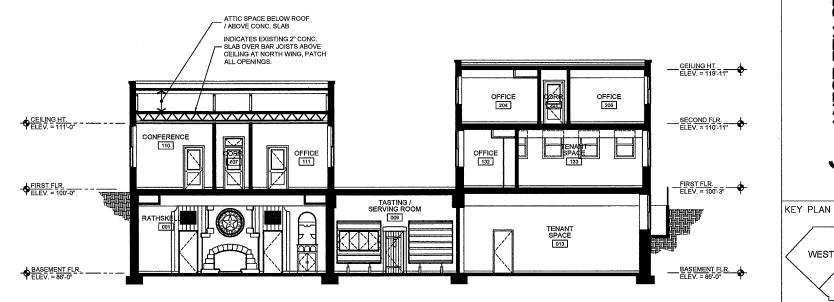

BUILDING SECTION 4 A400 SCALE: 1/8" = 1'-0"

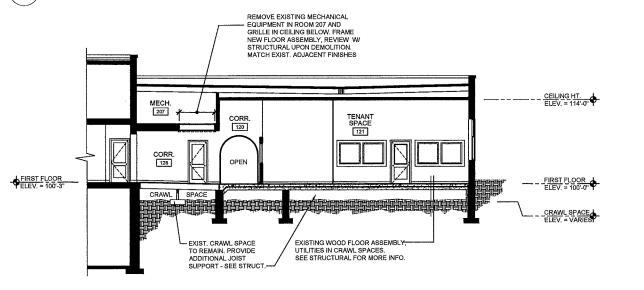

HAGEN, CHRISTENSEN TEL (611) 504-1227 - FAX (612) 504-7

I hereby certify that this drawing me or under my direct supervision a duly registered architect und the State of Minnesota.

/ Date Architect Registration Number 16366

W. 7th/Ft. Road Fo

Rathskeller & Offic

Building Renovation

WEST 7TH STREET/ FORT ROAD FEDERATION




NC WEST SOUTH


REVISIONS:

ISSUED FOR **BUILDING PERMIT** 16130

12/07/2017


Building Sections

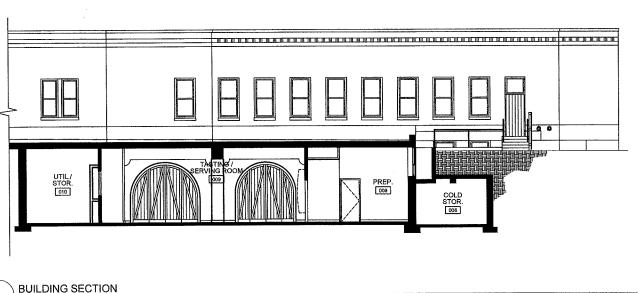


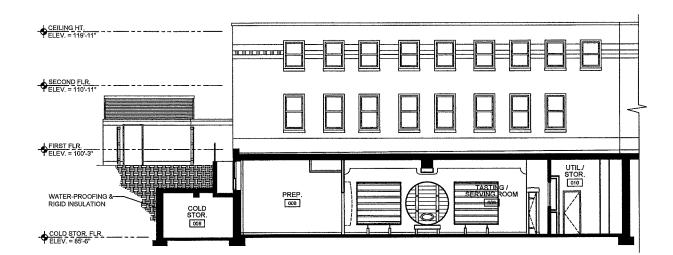






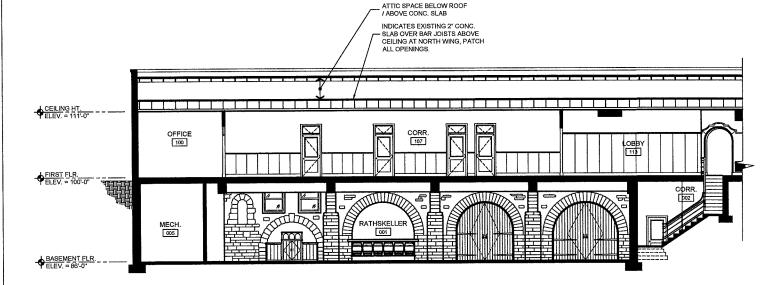


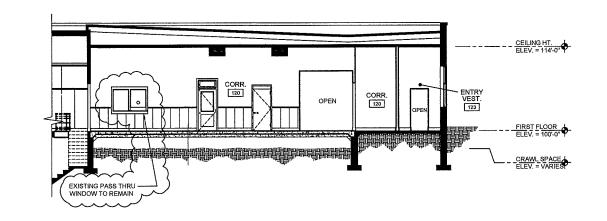





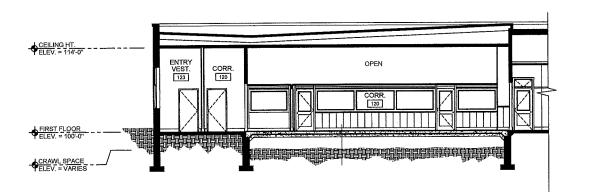

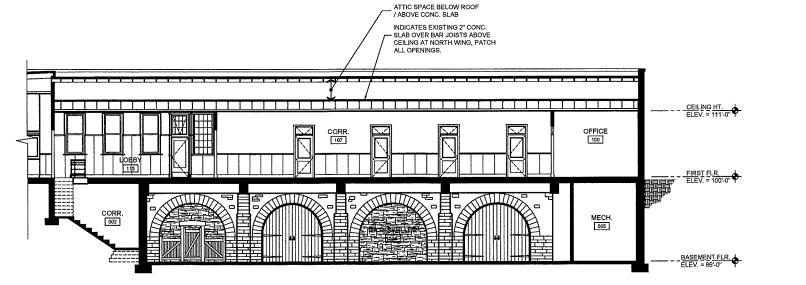

HAGEN, CHRISTENSEN & ard Croar Avenue bo. - Minneapolis, Mi

TEL (112)001-1012 - FAX (113)004-7 I hereby certify that this drawing me or under my direct supervision a duly registered architect und

/ Date Architect Registration Number

W. 7th/Ft. Road Fe

Rathskeller & Offic

Building Renovation

WEST 7TH STREET/ FORT ROAD FEDERATION




KEY PLAN NC WEST SOUTH

REVISIONS:

ISSUED FOR **BUILDING PERMIT**

Comm. No. 16130 12/07/2017

Building Sections

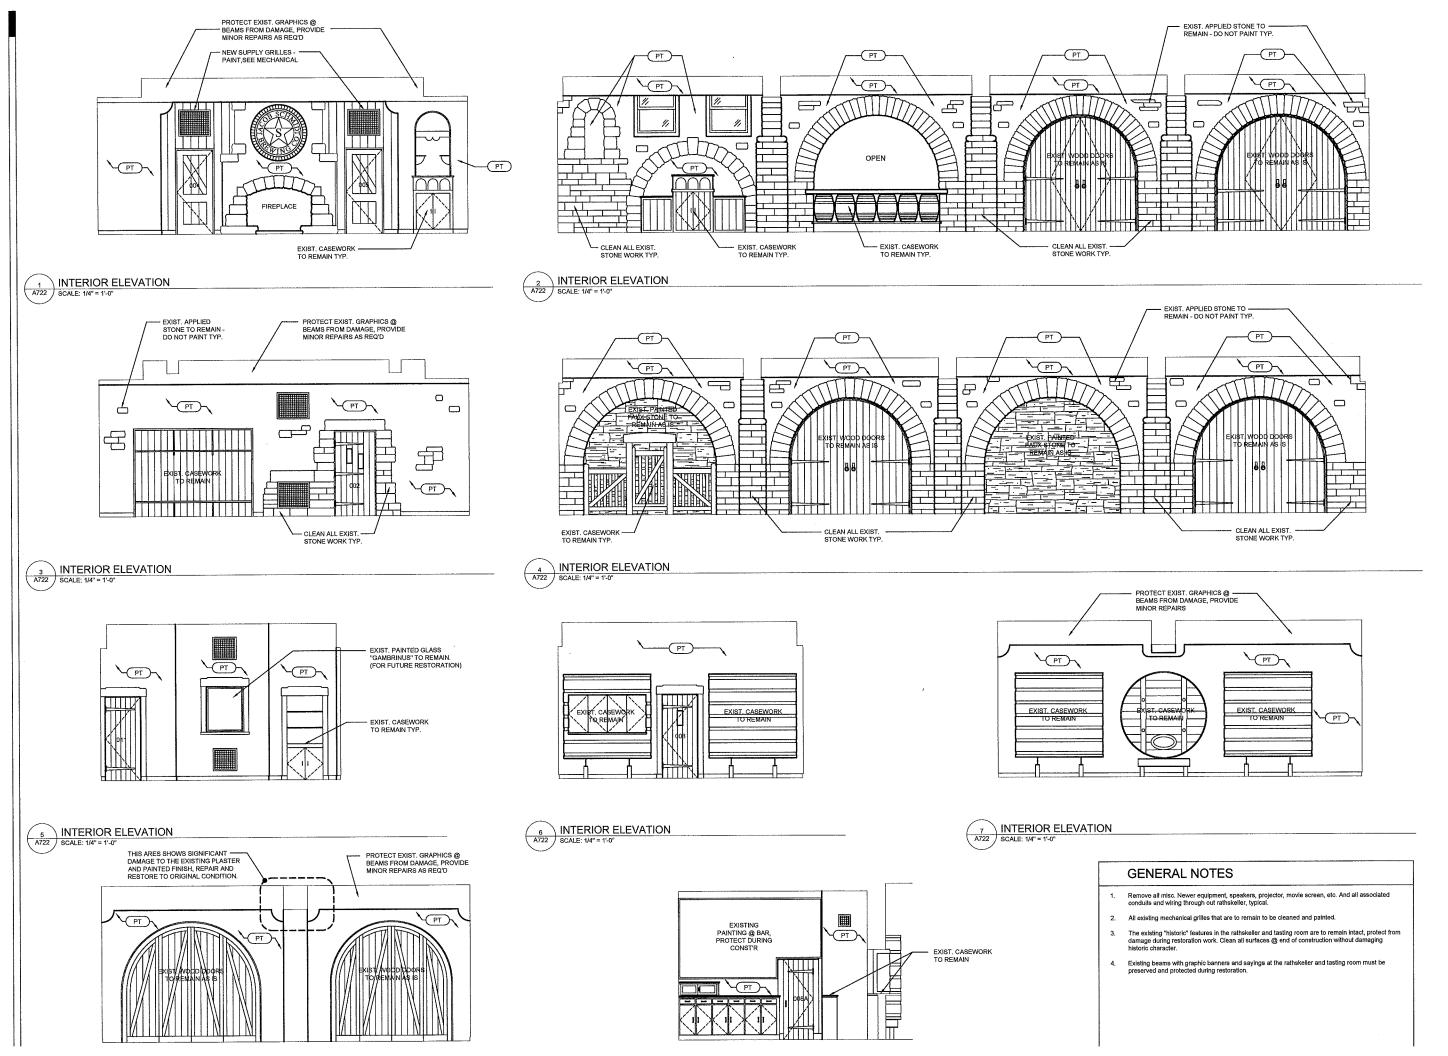

HAGEN, CHRISTENSEN & ARCHITECTS

Tel. (\$12) 851-1822 • FAX (\$12) 864-70

I hereby certify that this drawing me or under my direct supervision a duly registered architect und the State of Minnesota.

By

By
Title Architect Date
Registration Number 16366

W. 7th/Ft. Road Fo

Rathskeller & Offic Building Renovation

> WEST 7TH STREET/ FORT ROAD FEDERATION



KEY PLAN

WEST NO SOUTH


REVISIONS:

ISSUED FOR BUILDING PERMIT

Comm. No. 16130

12/07/2017 Sheet Title

Interior Elevations

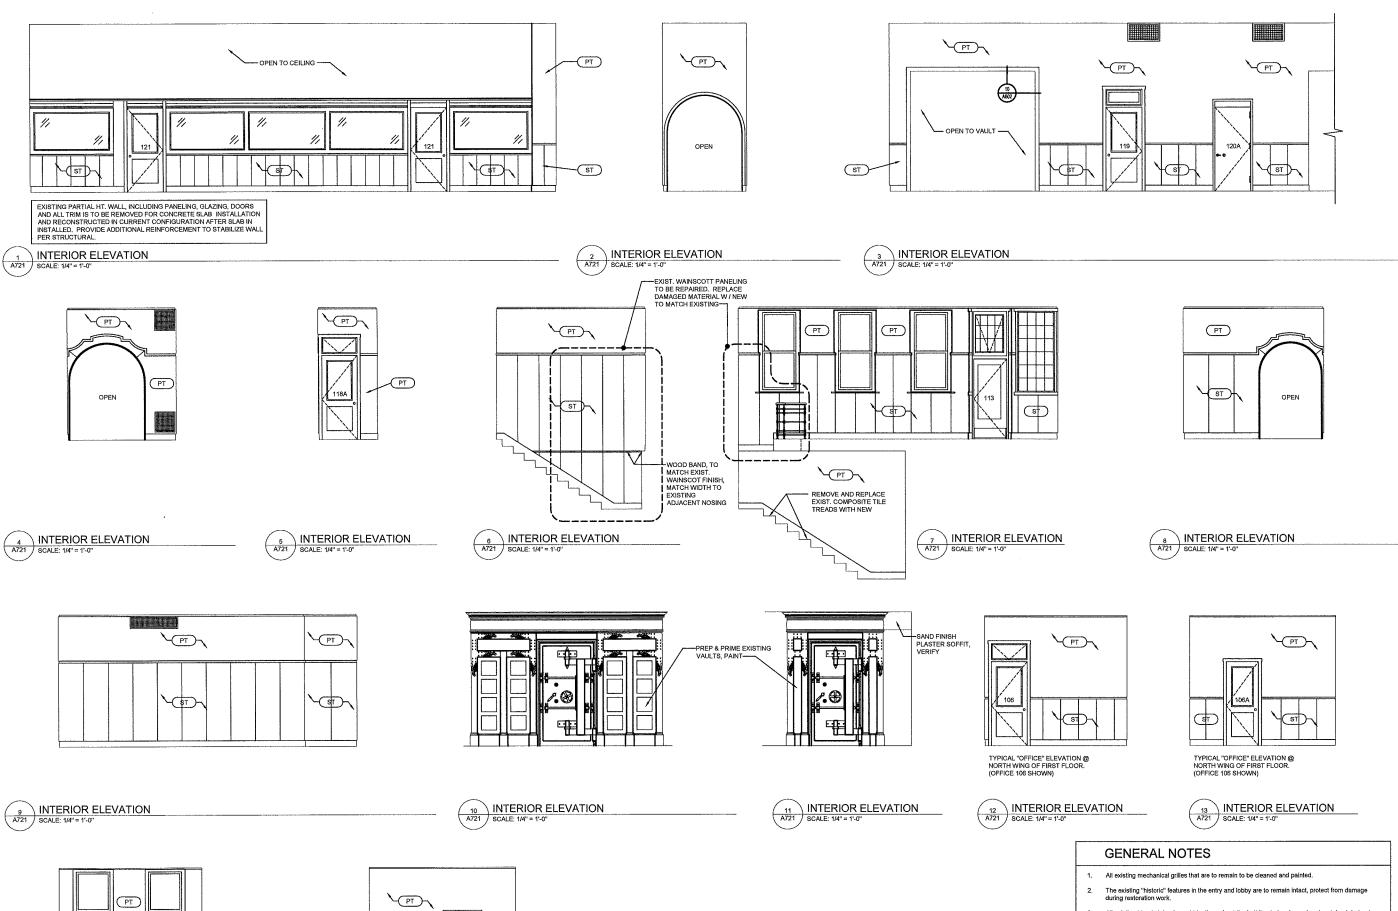

HAGEN, CHRISTENSEN &
ARCHITECTS TEL (\$12) 804-1892 • FAX (\$13) 994-71

I hereby certify that this drawing me or under my direct supervision a duly registered architect und the State of Minnesota.

By


Date Architect 16366

Registration Number

W. 7th/Ft. Road Fe

Rathskeller & Offic **Building Renovation**


WEST 7TH STREET/ FORT ROAD FEDERATION

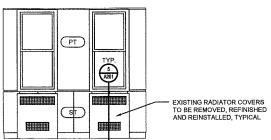

TYPICAL "OFFICE" ELEVATION @

NORTH WING OF FIRST FLOOR.



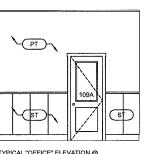

TYPICAL "OFFICE" ELEVATION @ NORTH WING OF FIRST FLOOR. (OFFICE 106 SHOWN)

All existing blond stained wood trim throughout the building to be cleaned and restained darker to closely match the original trim color.

Comm. No. 16130 12/07/2017

ISSUED FOR **BUILDING PERMIT**

KEY PLAN


REVISIONS:


WEST


NC


SOUTH


Interior Elevations

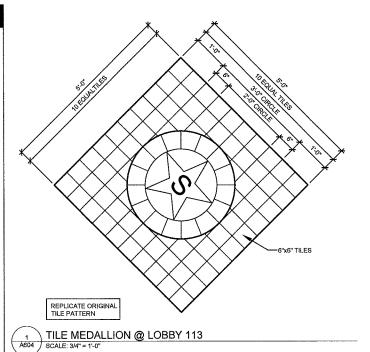

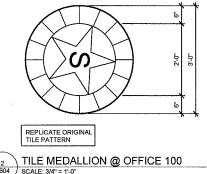

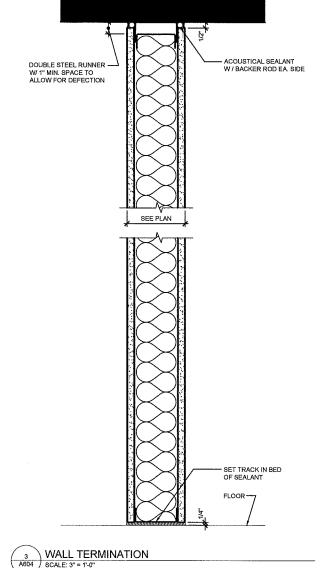


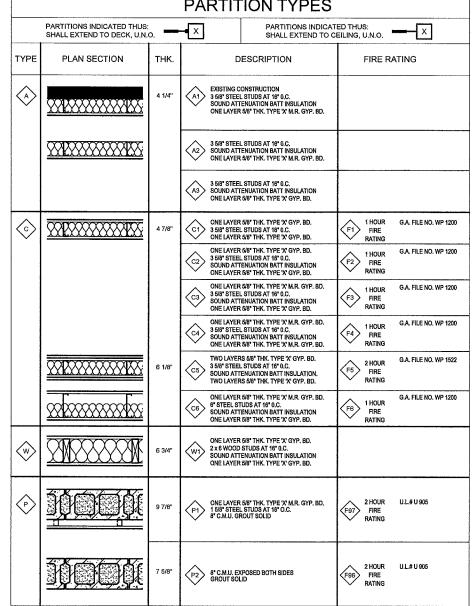

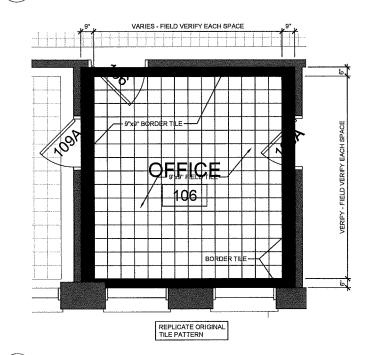

TYPICAL TILE PATTERN @ NORTH WING OFFICES / ROOMS

SCALE: 3/6" = 1'-0"

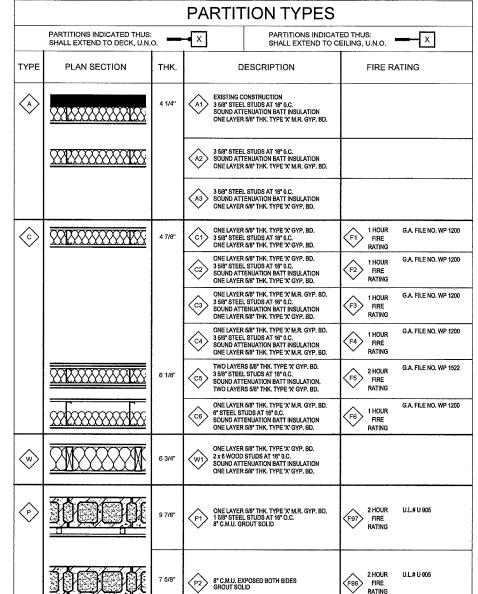

HAGEN, CHRISTENSEN ARCHITECTS 489 CHOW AVERUE BS - MINKEAPOLIS S


TEL (\$12)904-1222 - FAX (\$12)964-7

I hereby certify that this drawing me or under my direct supervisio a duly registered architect unc the State of Minnesota. / Date Title Architect

W. 7th/Ft. Road F

Rathskeller & Offic **Building Renovation**

WEST 7TH STREET/ FORT ROAD FEDERATION

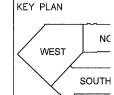


REVISIONS:

ISSUED FOR **BUILDING PERMIT**

16130 12/07/2017 Sheet Title Partition Types / M

Details

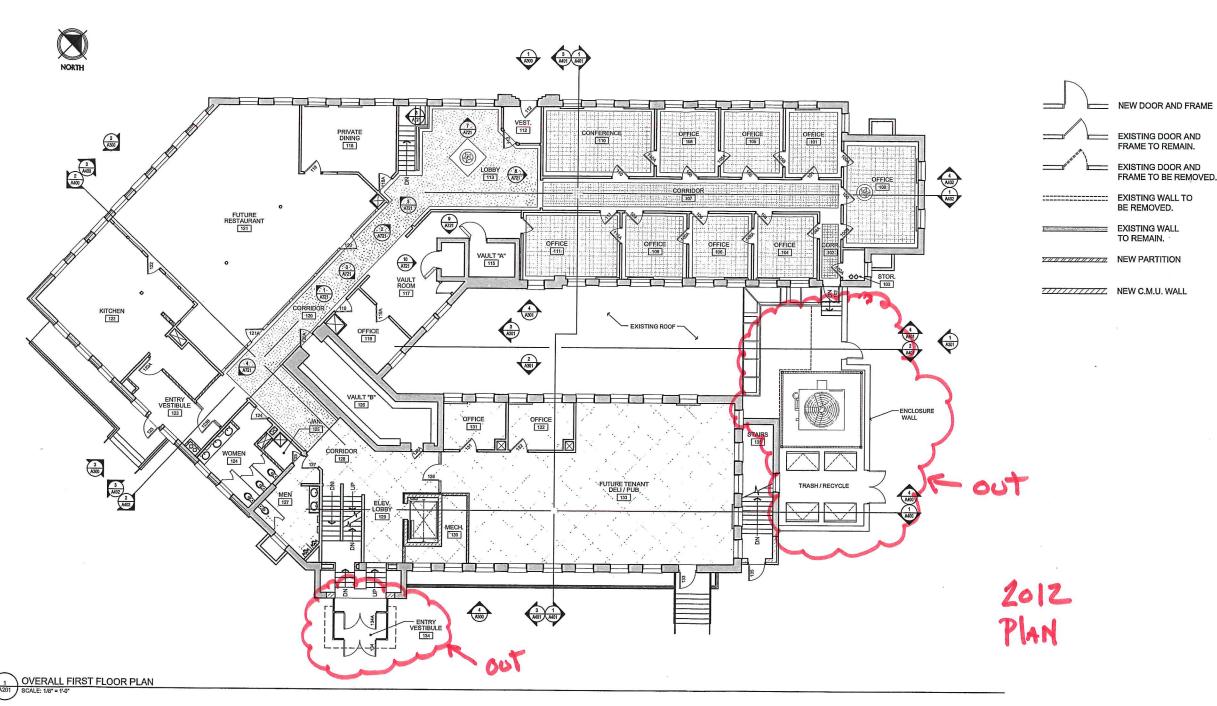

GENERAL NOTES: FIRST FLOOR PLAN

- All interior repair work to original materials and finishes are to be completed per the Department of Interior Preservation Standards.
- 2. In the north wing and corridor in the west wing the existing floor finish is a composite lite that is worn and has deteriorated due to moisture and structural movement. The intention is to repair where possible but likely replace most of the flooring with new material replicating the existing pattern. This includes the two locations with the Schmidt logo.
- Provide the necessary repair work to the existing terrazzo floors per specifications.
- Interior Doors: Wherever possible, historic paneled doors (and hardware) will be repaired rather than replaced. If replacement of original or historic doors is necessary, the replacement will duplicate or be compatible with the material, design, and hardware of the older.
- Windows: Provide repairs to existing original wood windows throughout. Replace existing newer anodized aluminum windows at west and south elevations with new clad wood windows to match original profile. At new windows match existing original masonry openings.

Windows Alternate: Provide aluminum clad wood windows to replace the existing windows throughout. Windows are to match existing original masonry openings.

- Repair and refinish existing wood trim, wainscot, and paneling. Where missing or in need of being replaced provide new wood trim and paneling to match.
- Provide patching and repair work as needed at existing plaster walls and ceilings that remain.
- Provide new acoustical tile ceilings at locations indicated in ceiling plan. Replicate original pattern and style.

- Provide one Hydraulic Passenger Elevator to serve
 all three floors
- Plumbing Fixtures: Existing plumbing fixtures may remain in some locations. Otherwise, replace existing plumbing fixtures with low flow type plumbing fixtures and related trim, fittings, and valves. Meet ADA requirements where required.
- Provide new concrete work at accessible ramp, sidewalks at east side, slab and footings for cooling tower and trash area.
- 12. Repair existing area wells and provide new railings.

GLENDENING

974 West Seventh Street Saint Paul, Minnesota 55102 (651) 225-9926

> West 7th / Fort Road Federation

Saint Paul, Minnesota

Rathskeller - Office Building Schmidt Brewery Redevelopment Saint Paul, Minnesota

KEY PLAN

12/20/2011	
	12/20/2011

CAD DWG FILE:
DRAWN BY: WO / JG
CHECKED BY:

SHEET TITLE:
Overall First Floor Plan

REVISIONS:

Overall filst floor fla

HEET NUMBER:

A201-P


















GLENDENING ARCHITECTURAL SERVICES INC.


974 West Seventh Street Saint Paul, Minnesota 55102 (651) 225-9926

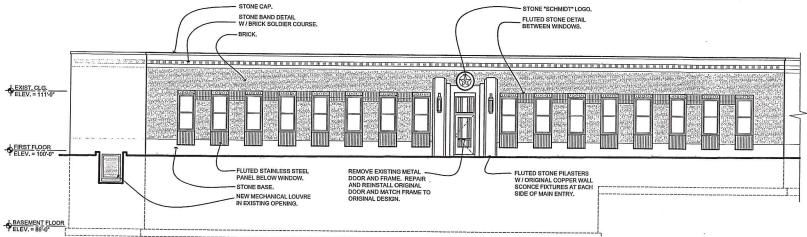

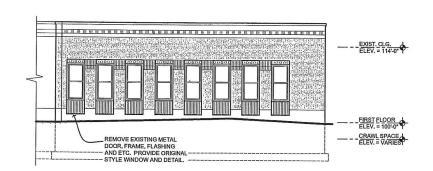



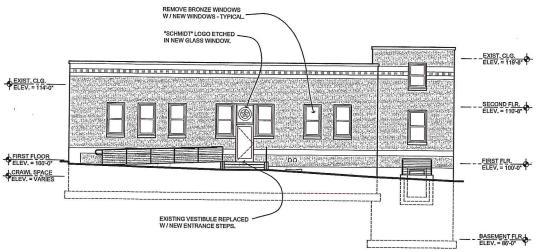

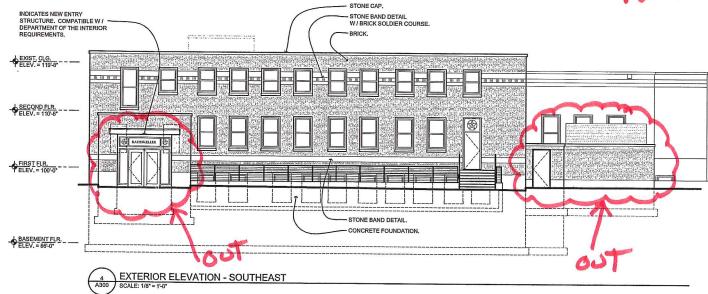

SCALE: 1/8" = 1'-0"


EXTERIOR ELEVATION - SEVENTH STREET

A300 SCALE: 1/8" = 1'-0"







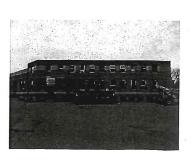







Saint Paul, Minnesota

West 7th / Fort Road

Federation

Rathskeller - Office Building Schmidt Brewery Redevelopment

Saint Paul, Minnesota

KEY PLAN

ISSUE:	12/20/2011
PROJECT NO:	
CAD DWG FIL	E:
DRAWN BY:	WO/JG
CHECKED BY:	

Exterior Elevations

SHEET NUMBER:


A300-P



EXTERIOR ELEVATION - EAST

SCALE: 1/8" = 1'-0"



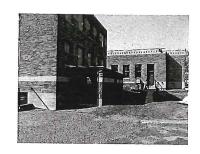








GLENDENING ARCHITECTURAL SERVICES INC.

974 West Seventh Street Saint Paul, Minnesota 55102 (651) 225-9926

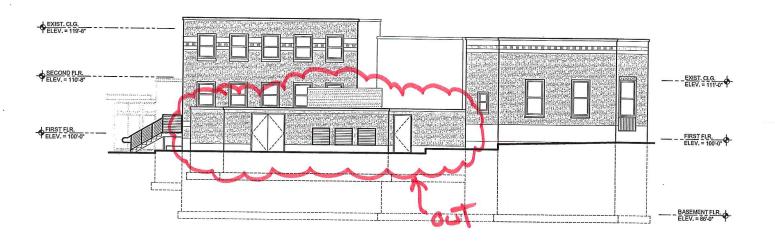

2012 PIAN















West 7th / Fort Road Federation Saint Paul, Minnesota

Rathskeller - Office Building Schmidt Brewery Redevelopment

Saint Paul, Minnesota KEY PLAN

ISSUE:	12/20/2011
PROJECT NO:	
CAD DWG FIL	E:
DRAWN BY:	WO/JG

SHEET TITLE: **Exterior Elevations**

A301-P